Project:

the private house in El Palol

property: Mas Palol (Can Fages), municipal area: Torroella de Fluvià, county: l'Alt Empordà, Spain

Investor:

Zain Maitreya, s.I., Margenat 23, 08017 Barcelona, Spain



ak. arch. Oldřich Hozman

Na Zájezdu 16, 101 00 Praha 10

Czech Republic


Czech Chamber of Archifects Reg. no.: 01284

tel + 4 2 0 2 3 5 3 1 1 6 2 2

www.arc.cz | arc@arc.cz

Architect: ak. arch. Oldrich Hozman	Drawn by: Ing. arch. Jan Soukup Ing. Tomas Stopka	Profession: CONSTRUCTION	Format: A4, A3
Structural engineer:		Checked by:	
Joan Carles Capilla Ten and Maria Pia Monaco Baques, arquitectes		arch. Arturo de la Maza	

Drawing:	Project stage:	EXECUTIVE PROJECT	Drawing number:
STRUCTURAL	Scale:		СТ
DETAILS	Date:	07 / 2011	51

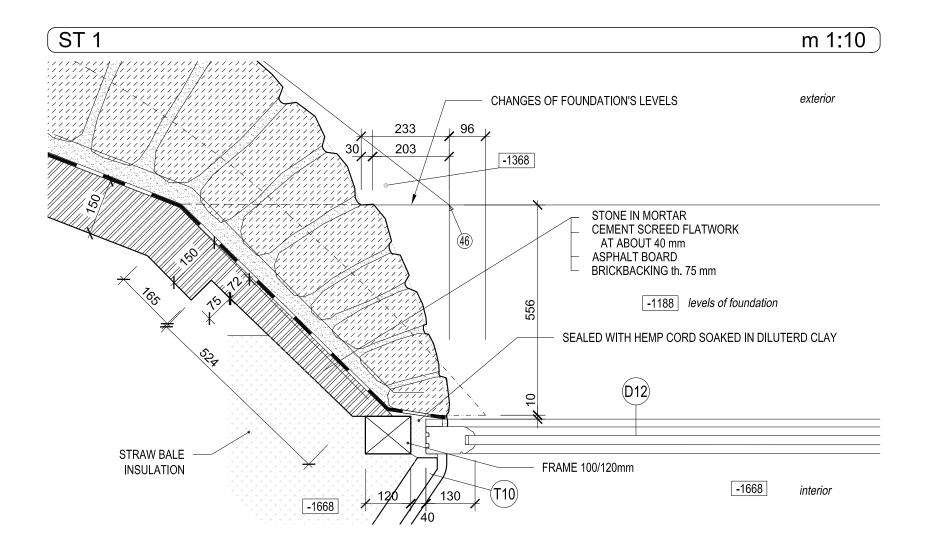

- 1 All work to be done according to current regulations and technology rules, including health and safety.
- 2. In case of any doubt, uncertainity or unforseen circumstances consultation with the

architect is needed to clarify progress of work.

3. Drawing of individual professions and other documentation on the list are part of the

main drawing. It is necessary to coordinate building structure drawings and adjustments made by other professions.

the Key of materials:

Stones in cement mortar (foundations)

(foundation Stone wall

(exposed stonework)

Clay bricks
Fired bricks

Cement screed for closing top of the stone wall

Gravel

______Terrain

Stone Arch

Foam glass

Timber structure element

Stone

sub-base - burnt expanded clay pearles (LIAPOR)

Asphalt board

DETAIL:

STRUCTURAL SOCLE ENDING NEAR THE DOOR DETAILS


State of the project: EXECUTIVE PROJECT

Scale: 1:10

Date: 07 / 2011

Drawing number:

ST 7 detail in section S1-S1' m 1:20

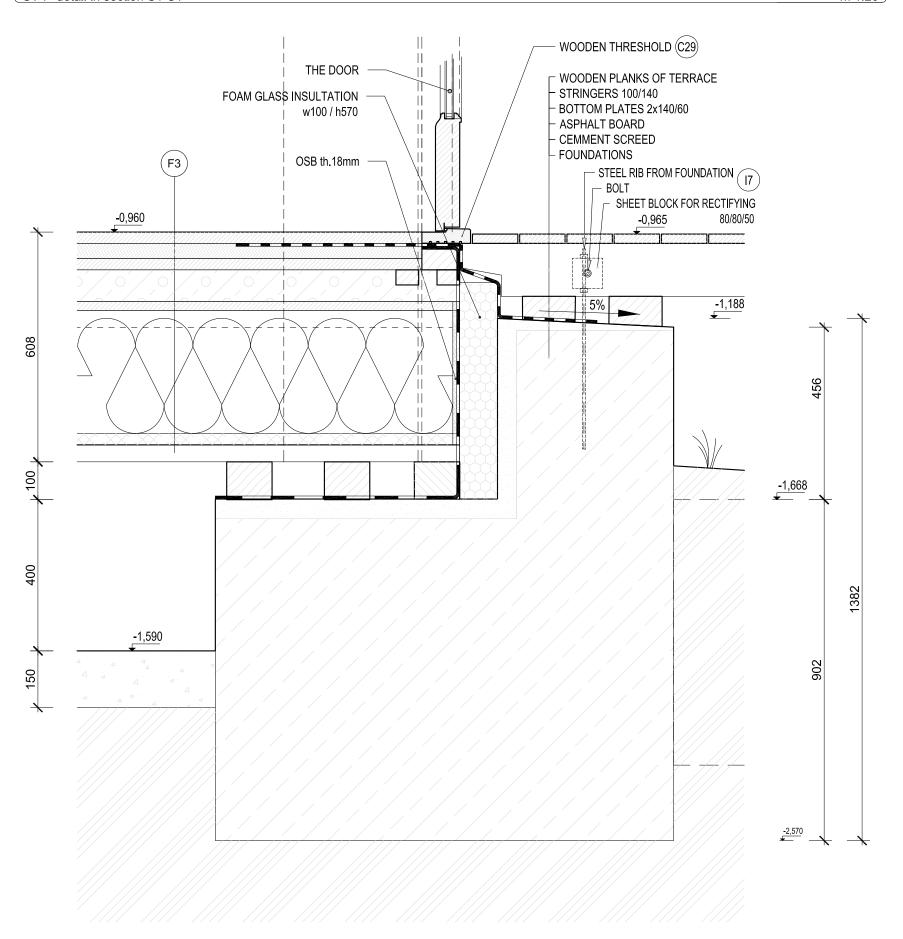

Notes:

- 1 All work to be done according to current regulations and technology rules, including health and safety.
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made by other professions.

the Key of materials:

Stones in cement mortar (foundations)

(loundation

Stone wall (exposed stonework)

Clay bricks

Cement screed for closing top of the stone wall

Fired bricks

Gravel

Terrain

Stone Arch

Foam glass

Timber structure element


Stone

sub-base - burnt expanded clay pearles (LIAPOR)

Asphalt board

DETAIL:

STRUCTURAL
DETAILS OF TERRACE IN SECTION S1-S1'

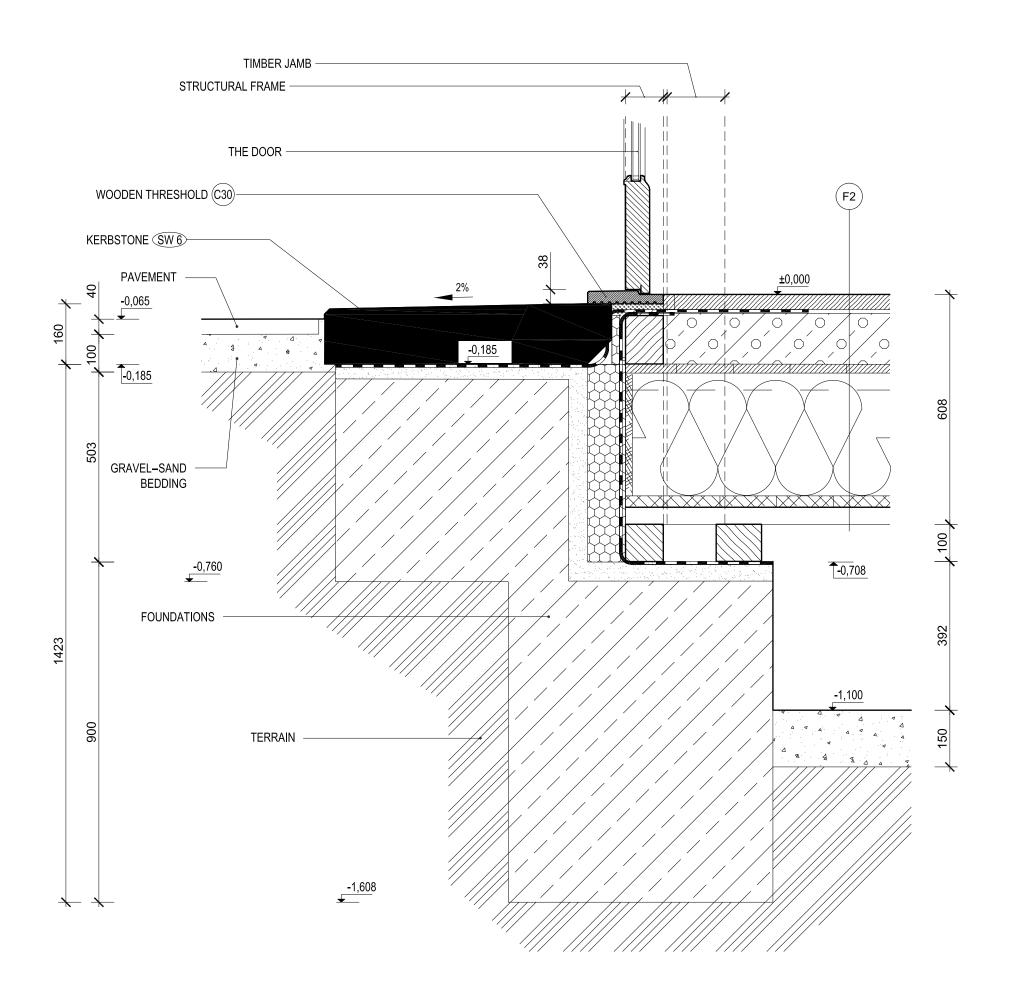

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main drawing. It is necessary to coordinate building structure drawings and adjustments made by other professions.

the Key of materials:

Stones in cement mortar (foundations)

Stone wall (exposed stonework)

Clay bricks

Fired bricks

Cement screed for closing top of the stone wall

1.41

Gravel

______Terrain

Stone Arch

Foam glass
Timber structure element

Stone

sub-base - burnt expanded clay pearles (LIAPOR)

---- Asphalt board

DETAIL:

STRUCTURAL
DETAIL OF THE MAIN DOOR ENTRANCE


State of the project:

Scale:


1:10

Date:

07 / 2011

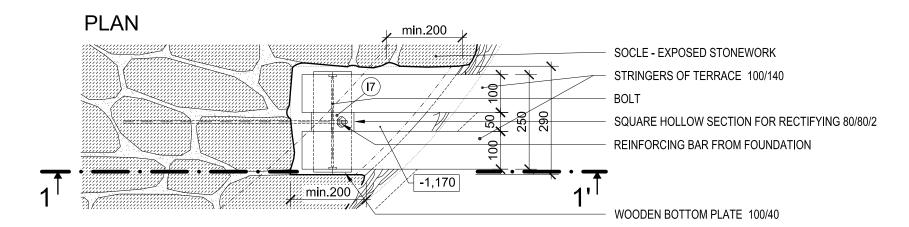

SECTION 1-1'

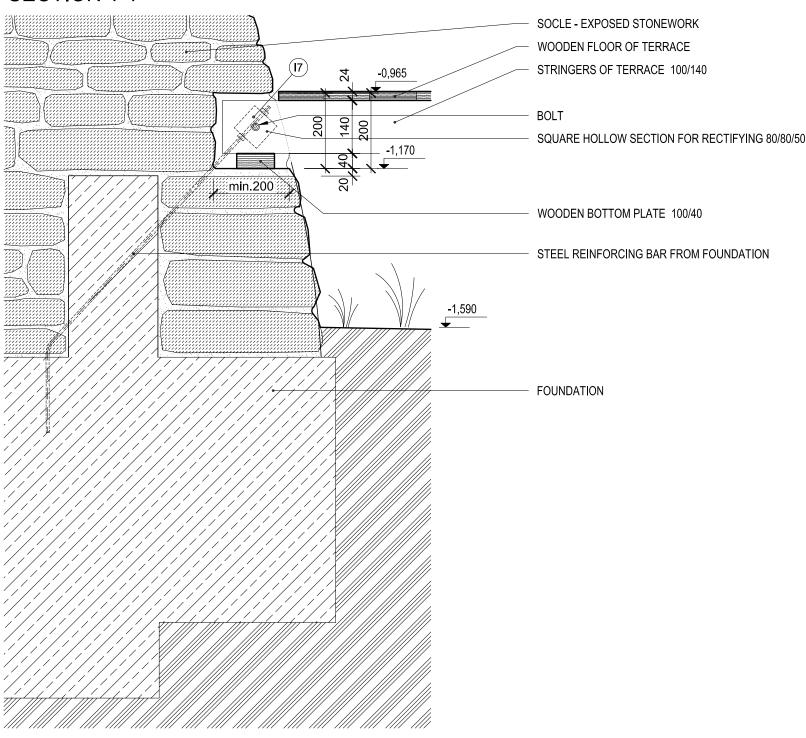

Notes:

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the Key of materials:

Stones in cement mortar (foundations)

Stone wall

(exposed stonework)

Clay bricks

Fired bricks

Cement screed for closing top of the stone wall

Gravel

////// Terrain

Stone Arch
Foam glass

Timber structure element

Stone

sub-base - burnt expanded clay pearles (LIAPOR)

---- Asphalt board


DETAIL:

STRUCTURAL
DETAIL POCKET IN SOCLE FOR TERRACE'S STRINGERS

State of the project:	EXECUTIVE PROJECT	Drawing number:
Scale:	1:10	
Date:	07 / 2011	

m 1:50

pockets in socle for terrace's stringers

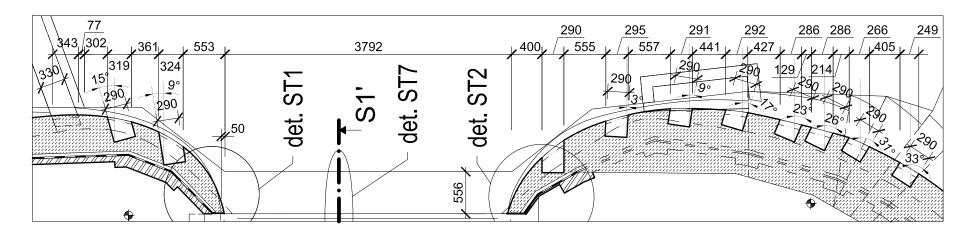

Notes

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- architect is needed to clarify progress of work.
- 3. Drawing of individual professions and other documentation on the list are part of the main drawing. It is necessary to coordinate building structure

drawings and adjustments

made by other professions.

the Key of materials:

Stones in cement mortar (foundations)

Stone wall (exposed stonework)

Clay bricks

Fired bricks

Cement screed for closing top of the stone wall

Gravel

Terrain

Stone Arch

Foam glass

Timber structure element



Stone

sub-base - burnt expanded clay pearles (LIAPOR)


Drawing number:

Asphalt board

DETAIL:

STRUCTURAL PLAN OF POCKETS IN SOCLE FOR TERRACE'S STRINGERS

State of the project:	EXECUTIVE PROJECT
Scale:	1:50
Date:	07 / 2011

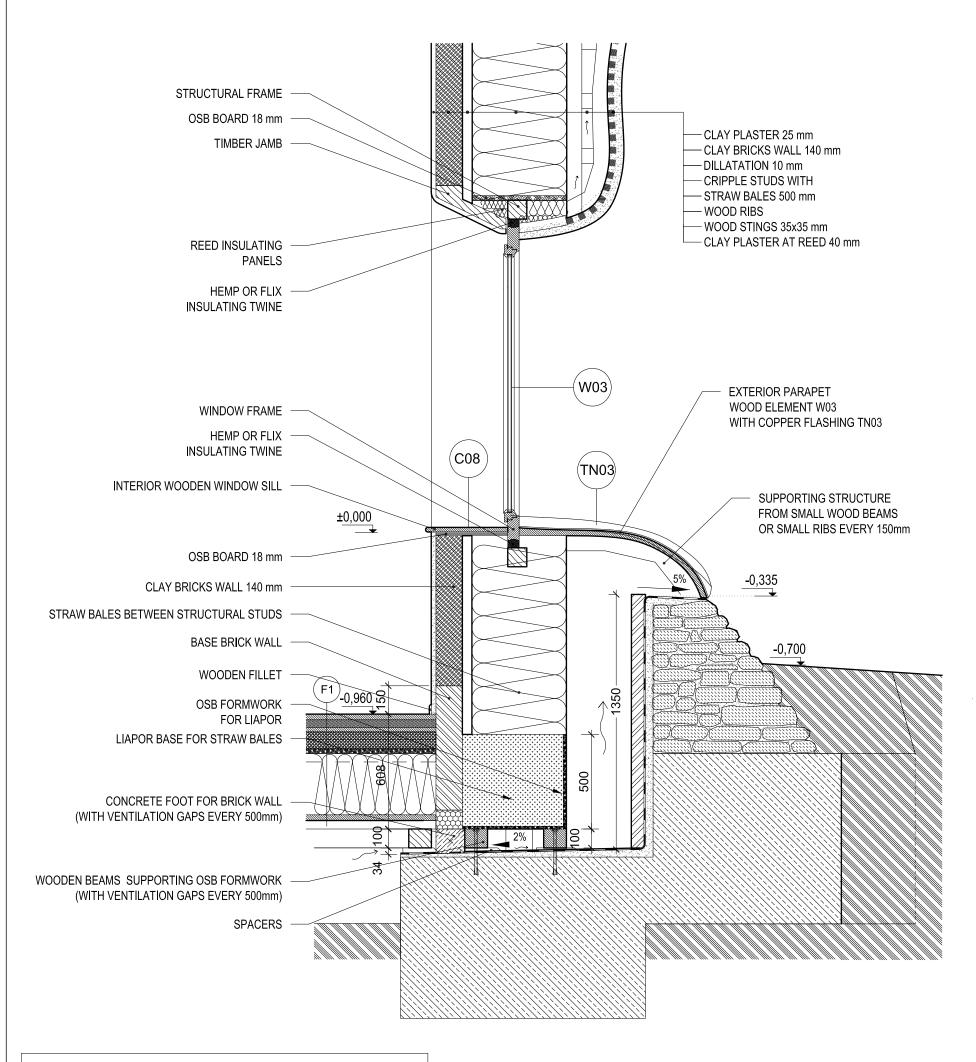

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the Key of materials:

Stones in cement mortar (foundations)

Stone wall (exposed stonework)

Clay bricks

Fired bricks

Cement screed for closing top of the stone wall

Gravel

///// Terrain

Stone Arch

Foam glass

Timber structure element

Stone

sub-base - burnt expanded clay pearles (LIAPOR)

Asphalt board


DETAIL:

STRUCTURAL
WINDOW SILL AND HEAD DETAIL

State of the project:	EXECUTIVE PROJECT	Drawing number:
Scale:	1:20	
Date:	07 / 2011	

ST14 - SWEEP ACCES MANHOLE - PLAN

m 1:20

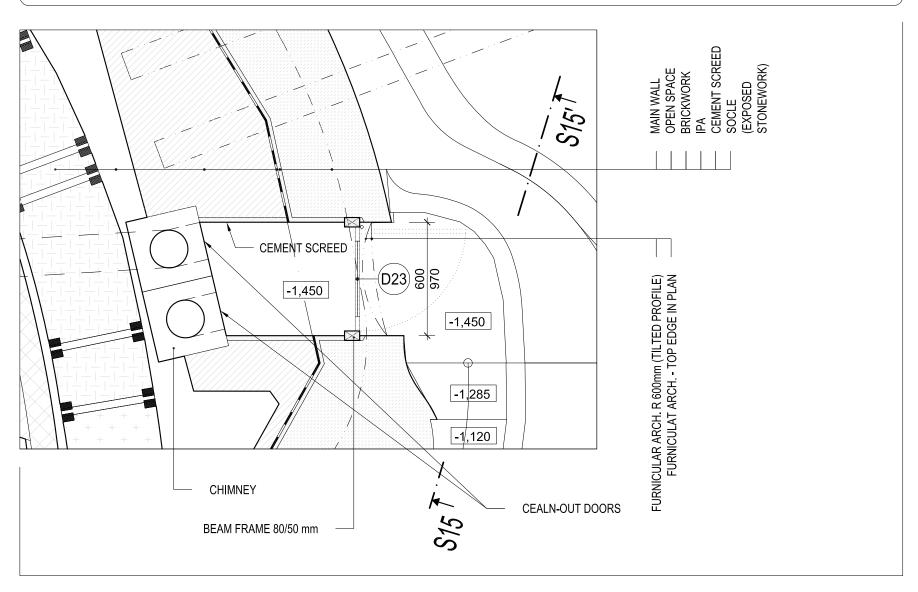

Notes:

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- architect is needed to clarify progress of work.
- 3. Drawing of individual professions and other documentation on the list are part of the

main drawing. It is necessary to coordinate building structure drawings and adjustments made by other professions.

(foundations)

Stones in cement mortar

the Key of materials:

Stone wall (exposed stonework)

Clay bricks

Fired bricks Cement screed for closing top of the stone wall

Gravel

Terrain

Stone Arch

Foam glass

Timber structure element

Stone


sub-base - burnt expanded clay pearles (LIAPOR)

Asphalt board

DETAIL:

STRUCTURAL DETAIL OF THE SWEEP ACCES MANHOLE

State of the project: Drawing number: EXECUTIVE PROJECT Scale: 1:20 Date: 07 / 2011

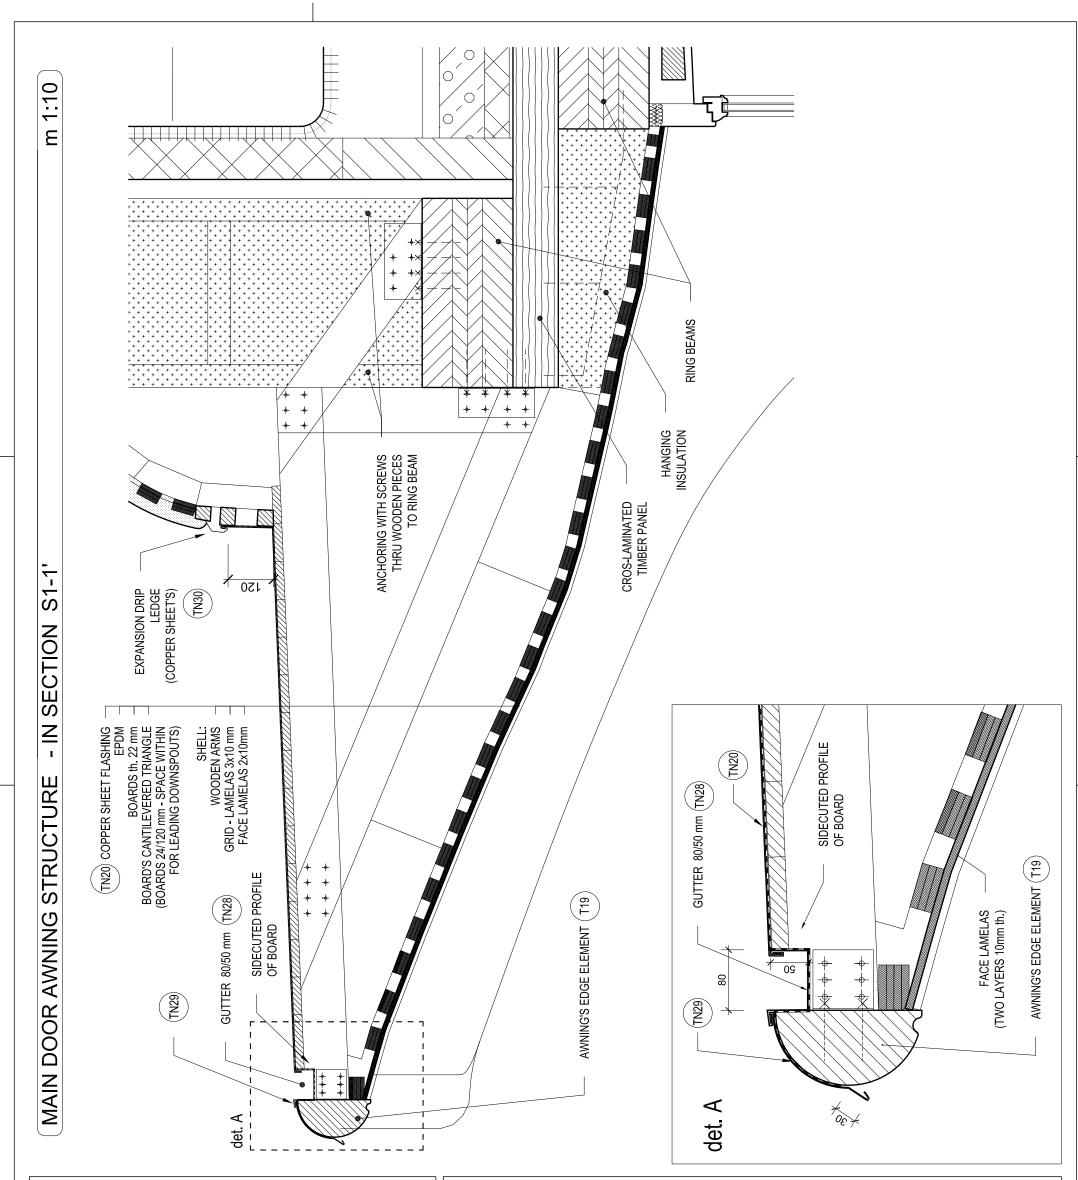

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- health and safety.

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- main drawing. It is necessary to coordinate building structure drawings and adjustments made by other professions.

the Key of materials:

Stones in cement mortar (foundations)

Stone wall (exposed stonework)

Clay bricks

Fired bricks
Cement screed for closing top of the stone wall

Gravel

______Terrain

Stone Arch
Foam glass

Timber structure element

Stone

sub-base - burnt expanded clay pearles (LIAPOR)


--- Asphalt board

DETAIL:

STRUCTURAL AWNING'S STRUCTURE (SECTION S1-1')


State of the project:	EXECUTIVE PROJECT	Drawing number:
Scale:	1:10	
Date:	06 / 2010	

m 1:50

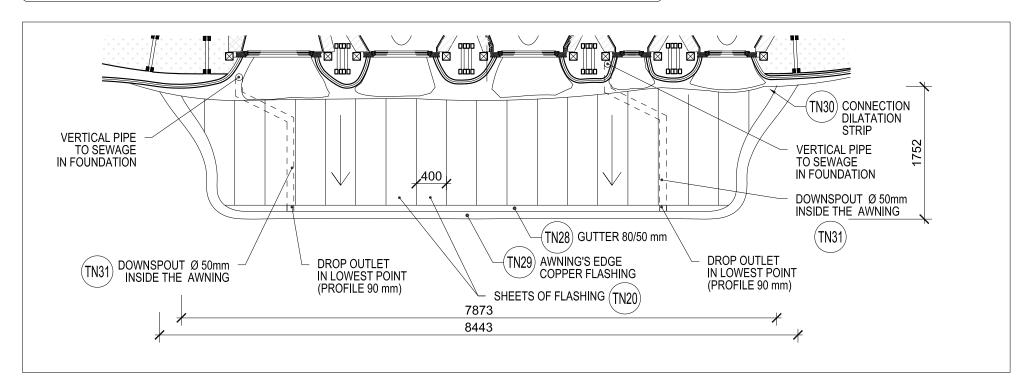

MAIN DOOR AWNING STRUCTURE - PLAN

m 1:50

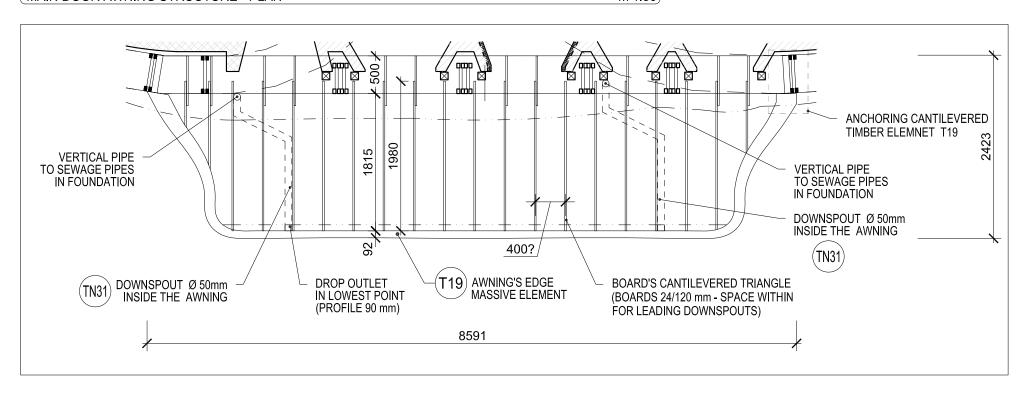

Notes:

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- architect is needed to clarify progress of work.

made by other professions.

- 3. Drawing of individual professions and other documentation on the list are part of the
- main drawing. It is necessary to coordinate building structure drawings and adjustments

the Key of materials:

Stones in cement mortar (foundations)

Stone wall (exposed stonework)

Clay bricks

Fired bricks

Cement screed for closing top of the stone wall

Gravel

////// Terrain

Stone Arch

Foam glass

Timber structure element

Stone

sub-base - burnt expanded clay pearles (LIAPOR)

--- Asphalt board

DETAIL:


STRUCTURAL
MAIN DOOR AWNING - PLAN, STRUCTURE IN PLAN

State of the project:

Scale: 1:50

Date: 07 / 2011

Drawing number:

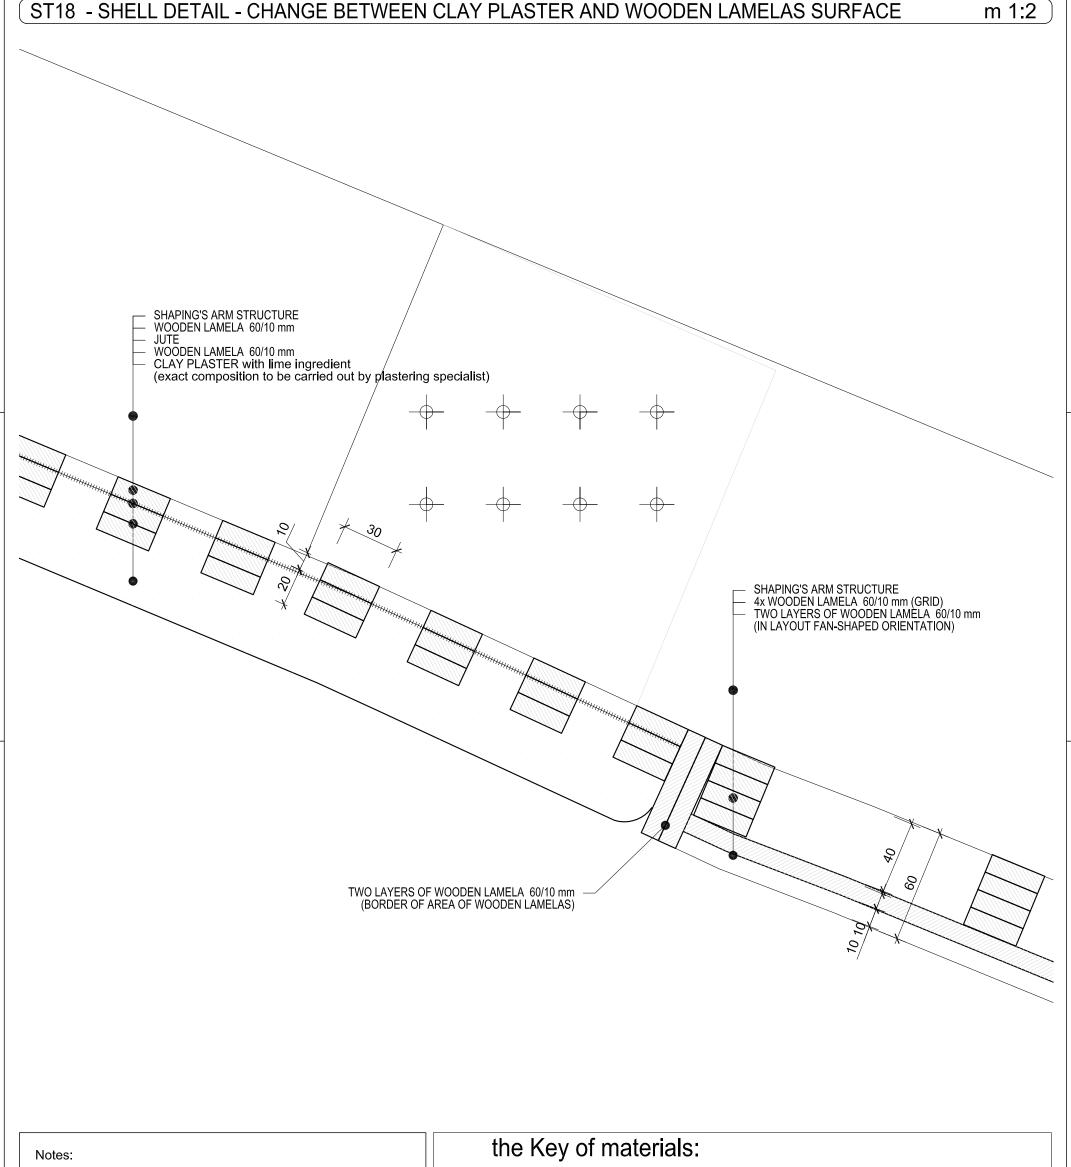

- 1 All work to be done according to current regulations and technology rules, including health and safety.
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Stones in cement mortar (foundations)

Stone wall

(exposed stonework)

Clay bricks
Fired bricks

Cement screed for closing top of the stone wall

Gravel

_______Terrain

Stone Arch
Foam glass

Timber structure element

Stone

sub-base - burnt expanded clay pearles (LIAPOR)


Asphalt board

DETAIL:

STRUCTURAL

DETAIL OF SHELL - CLAY PLASTER AND AREA OF WOODEN LAMELAS

State of the project:	EXECUTIVE PROJECT	Drawing number:
Scale:	1:2	
Date:	07 / 2011	

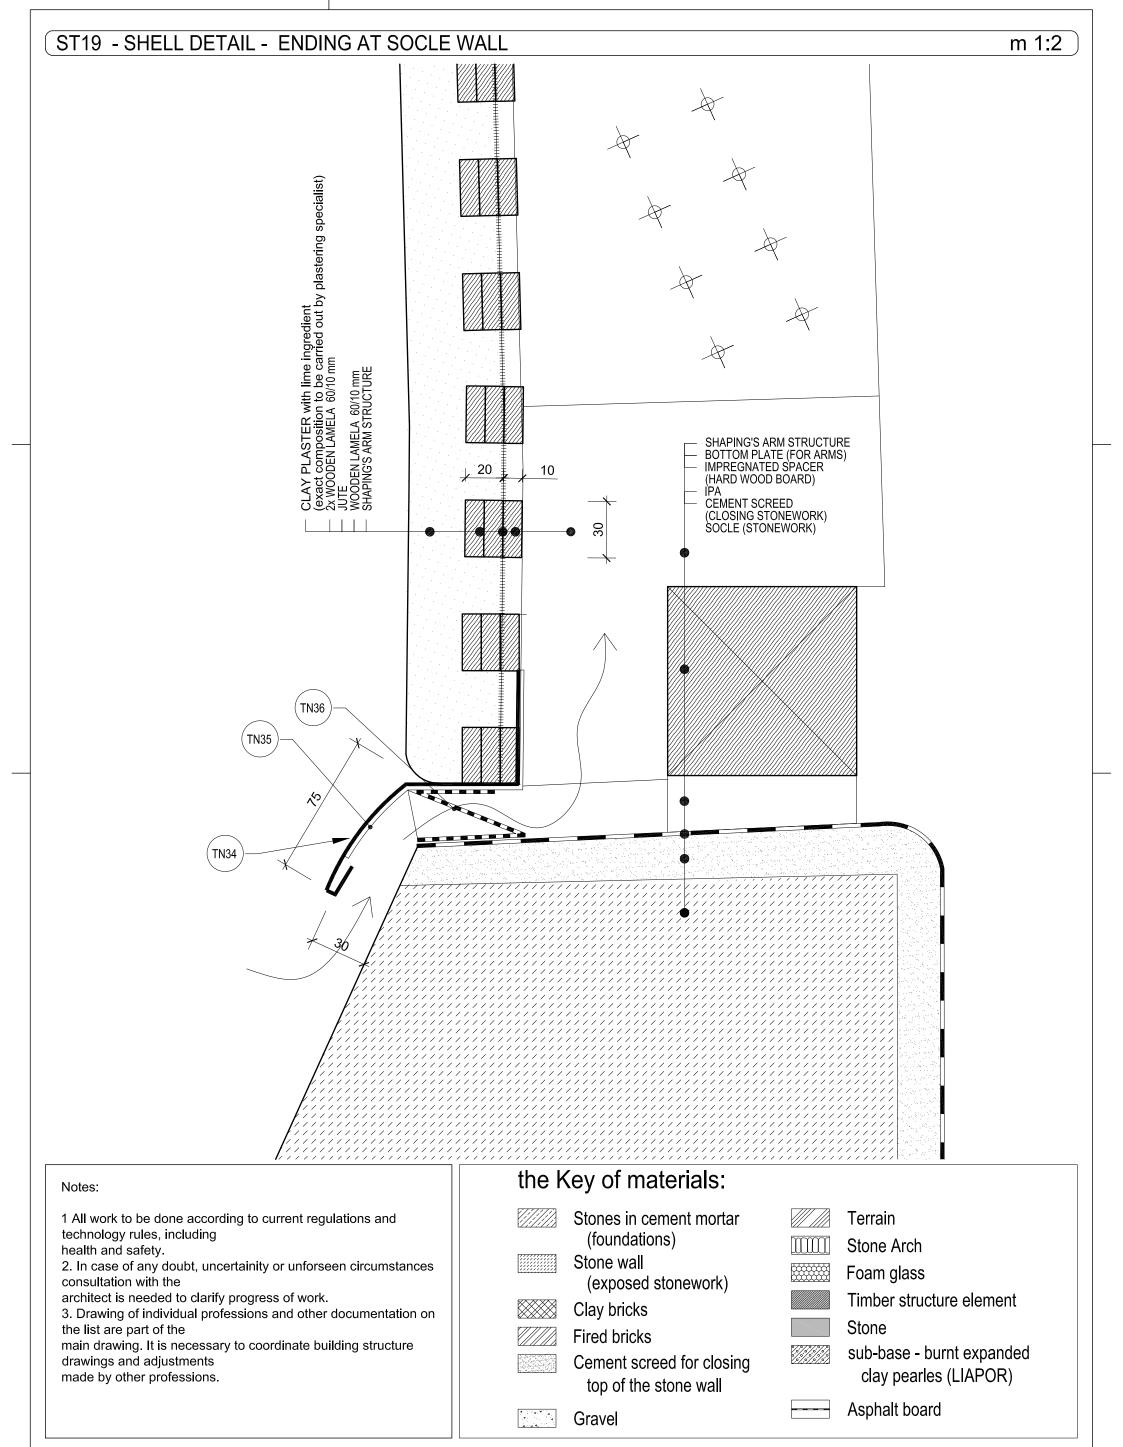

DETAIL:


STRUCTURAL
DETAIL OF SHELL - ENDING AT SOCLE WALL

State of the project:

Scale: 1:2

Date: 07 / 2011

Drawing number:

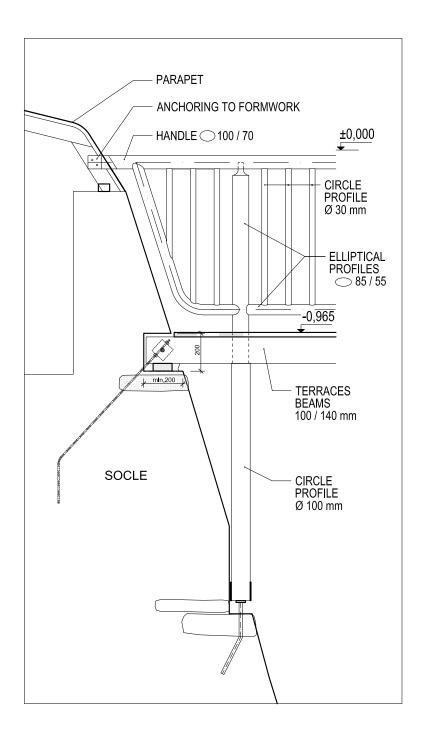

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Fired bricks

Cement screed for closing top of the stone wall

Gravel

Terrain

Stone Arch
Foam glass

Timber structure element

Stone

sub-base - burnt expanded clay pearles (LIAPOR)

Asphalt board

DETAIL:

STRUCTURAL


DETAIL OF TERRACE - COLUMN ON SOCLE AND RAILING'S ENDING

State of the project:	EVECUENCE PROJECT	┏
	EXECUTIVE PROJECT	1
Scale:	1:20	
Date:	07 / 2011	

Drawing number:

ST21 BALCONY EDGE WITH RAILINGS ANCHORING

m 1:10

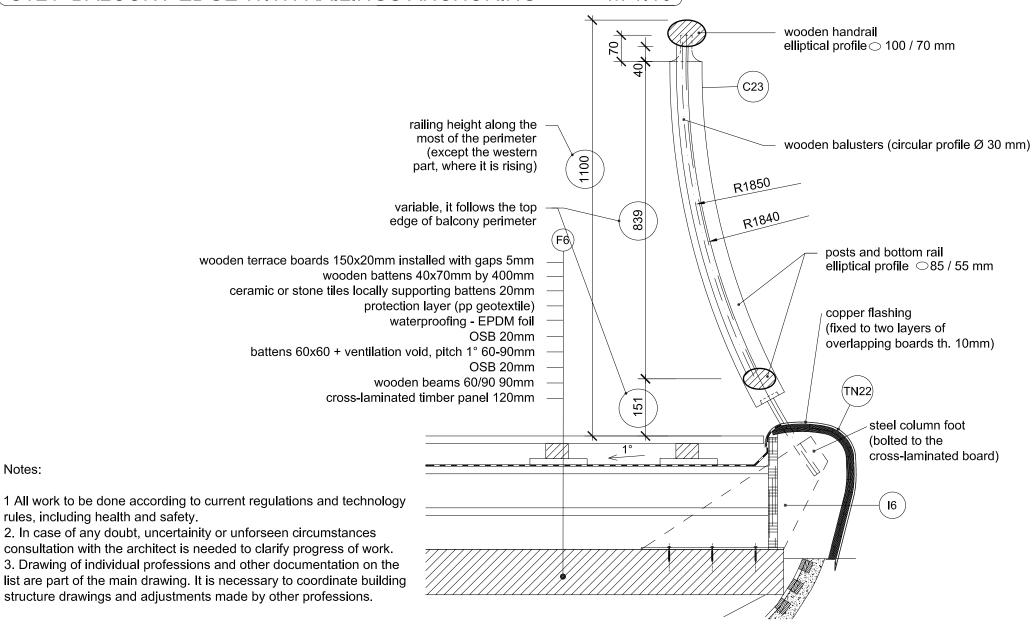


DETAIL:


Notes:

STRUCTURAL BALCONY EDGE WITH RAILING ANCHORING

State of the project:	EXECUTIVE PROJECT	Drawing number:
Scale:	1:10	
Date:	07 / 2011	

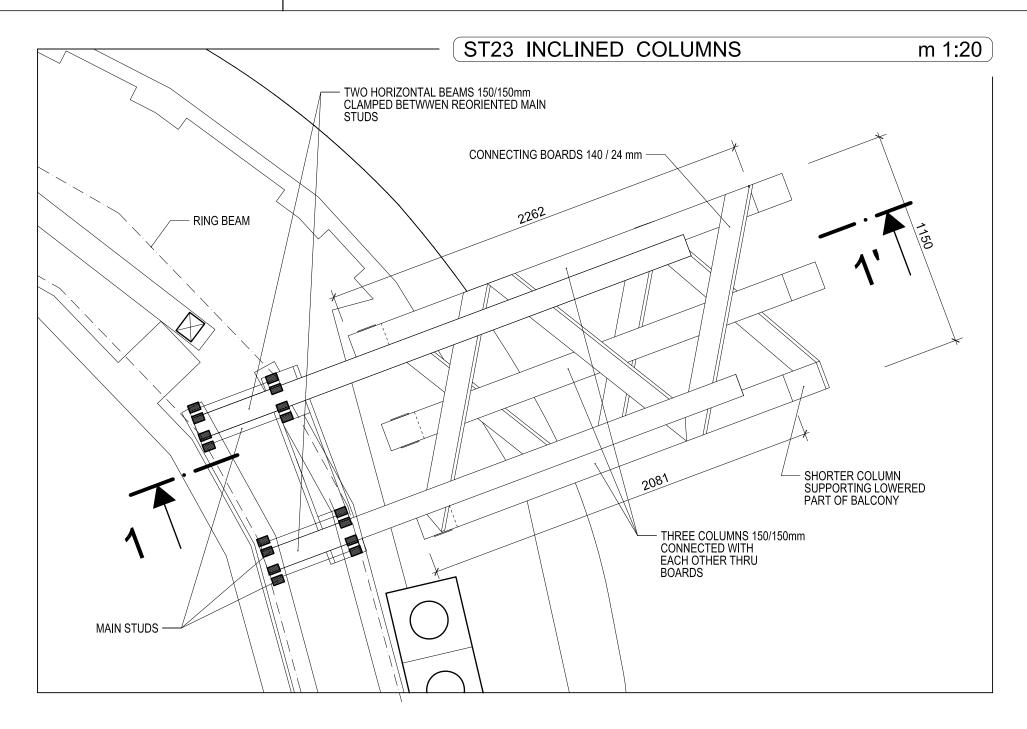

SECTION 1-1' m 1:50

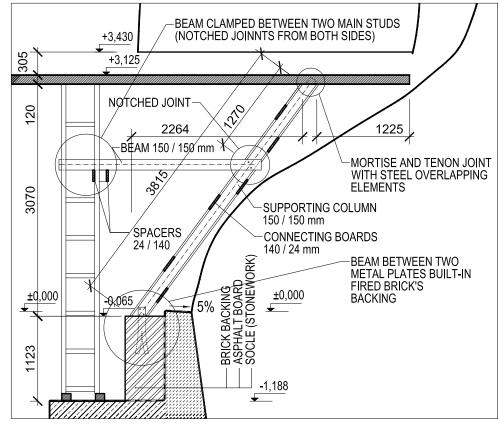

Notes:

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Stone wall
(exposed stonework)

Clay bricks

Gravel

Fired bricks

Cement screed for closing

top of the stone wall

Terrain

Stone Arch
Foam glass

Timber structure element

Stone

sub-base - burnt expanded clay pearles (LIAPOR)

Asphalt board


DETAIL:


STRUCTURAL
DETAIL OF INCLINED COLUMNS SUPPORTED BALCONY

State of the project:

Scale: 1:20, 1:50

Date: 07 / 2011

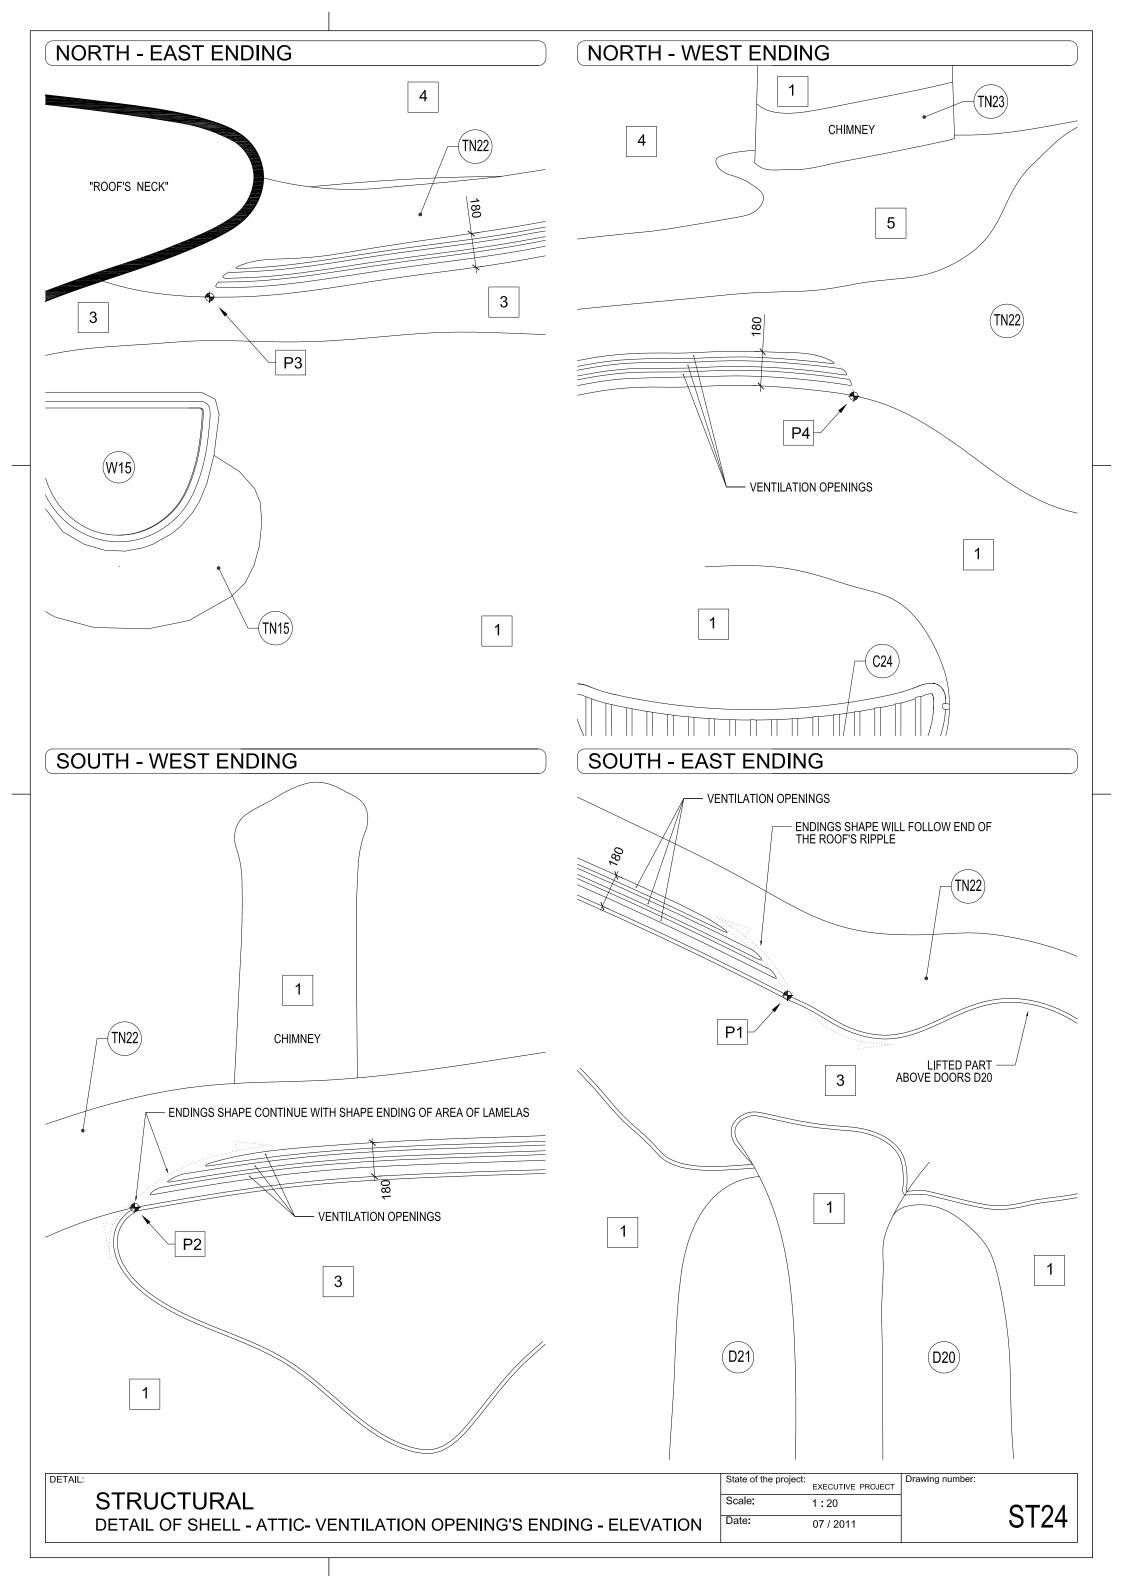

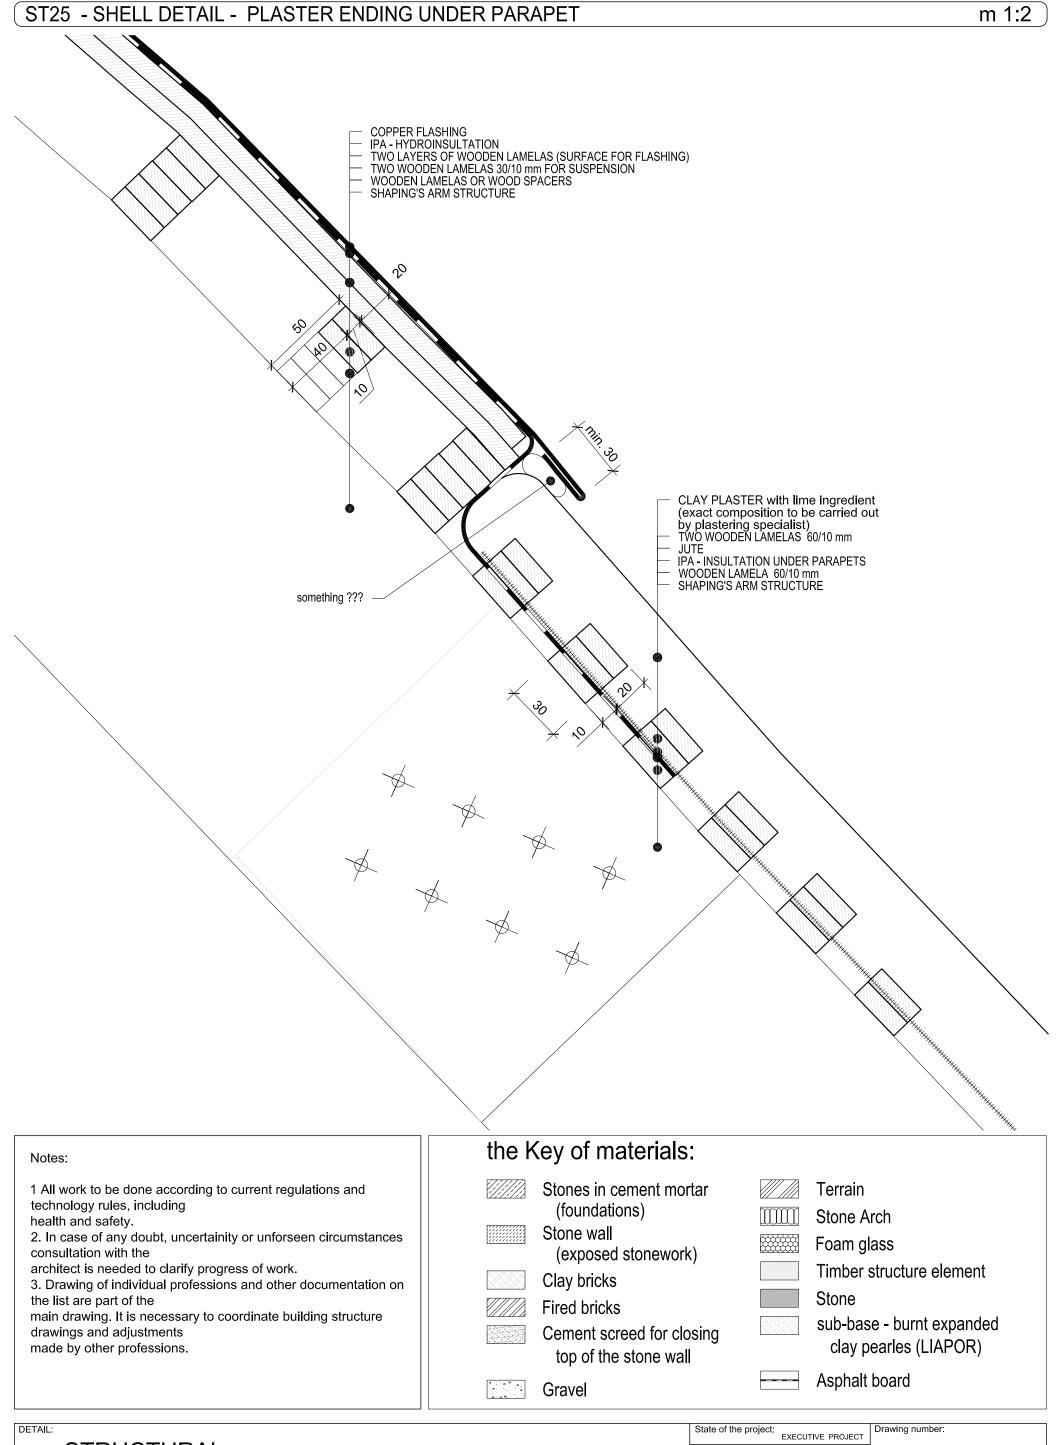


STRUCTURAL
DETAIL OF SHELL - PLASTER ENDING UNDER PARAPET, VERTICAL SECTION

State of the project: EXECUTIVE PROJECT


Scale: 1:2

Date: 07 / 2011

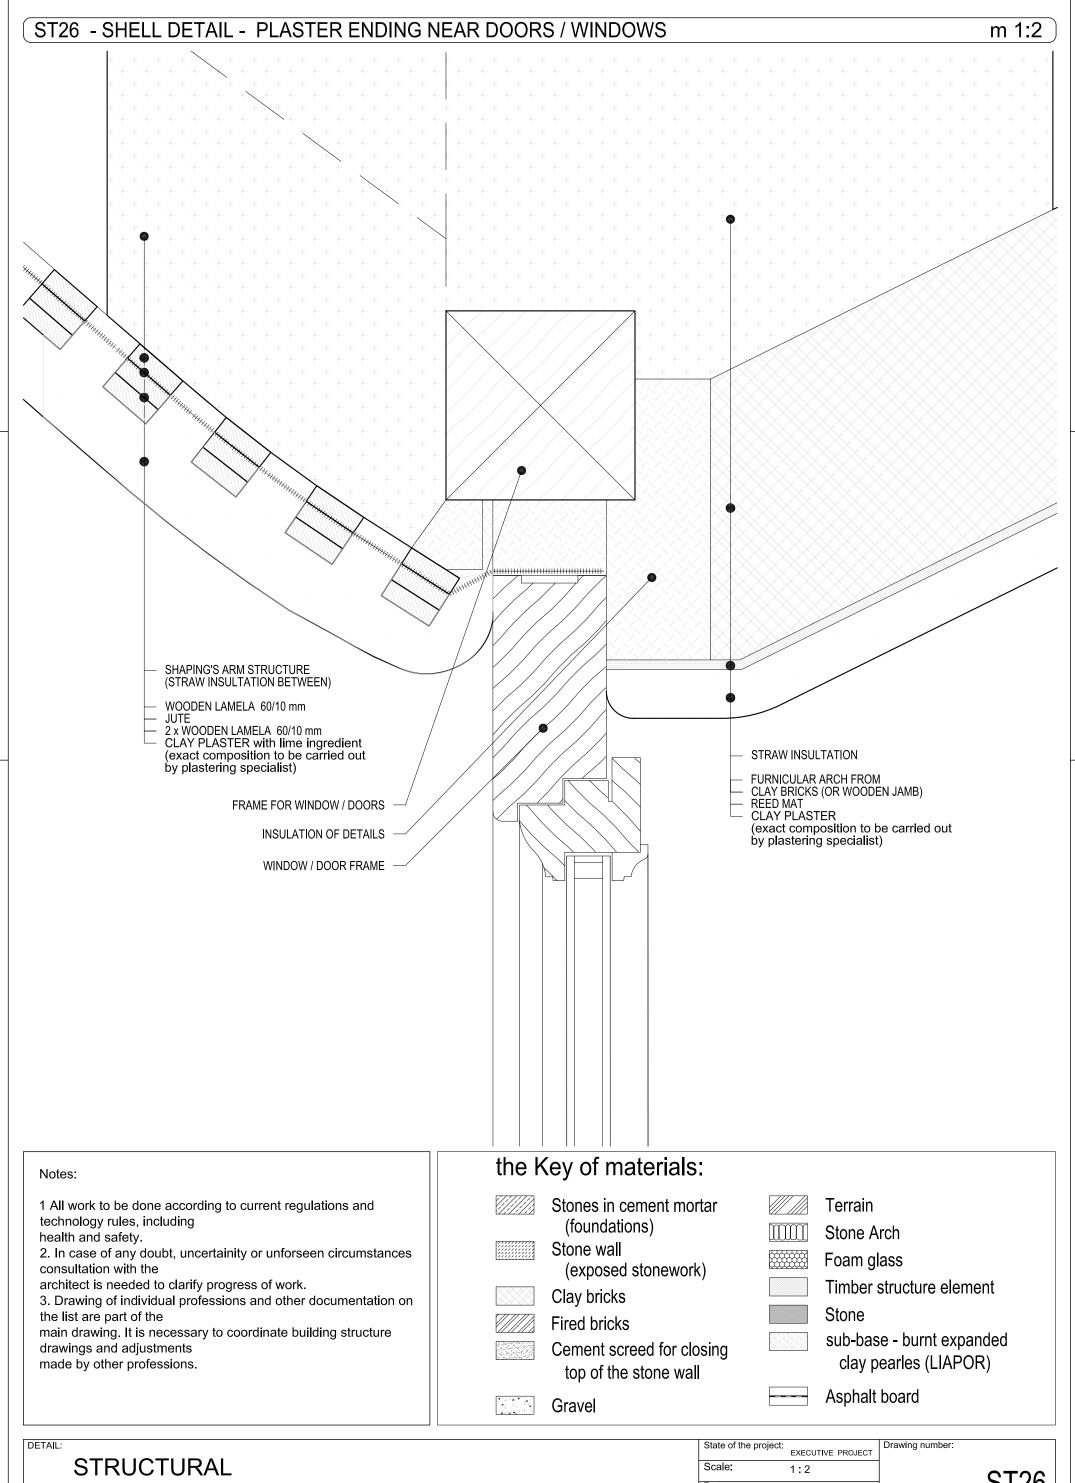

DETAIL OF SHELL - PLASTER ENDING NEAR DOORS / WINDOWS

Date: 07 / 2011

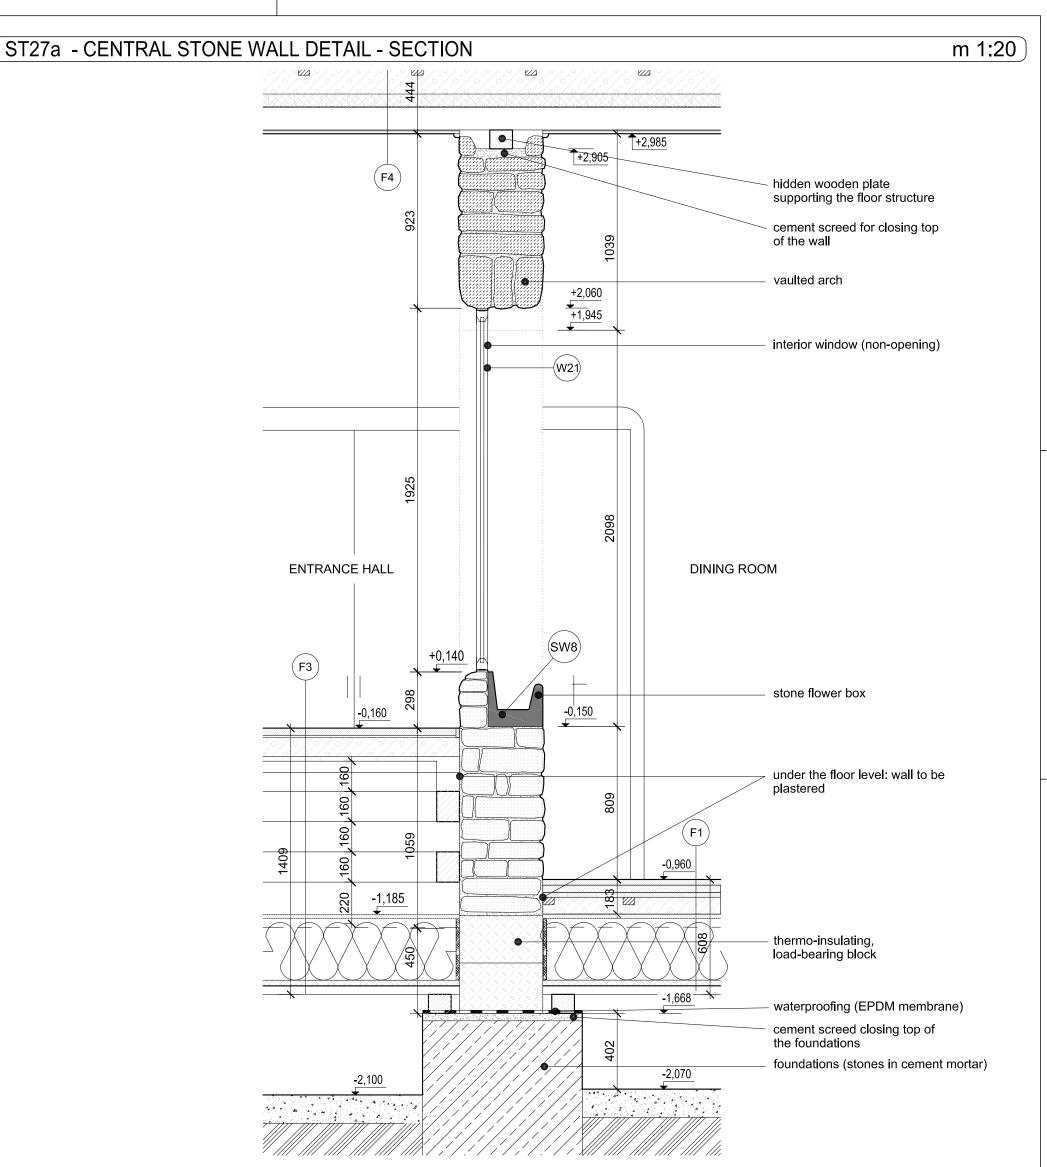



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Stones in cement mortar (foundations)

Stone wall

(exposed stonework)

Clay bricks
Fired bricks

Cement screed for closing top of the stone wall

Gravel

Terrain

Stone Arch

Foam glass

Timber structure element

Stone

sub-base - burnt expanded clay pearles (LIAPOR)


Asphalt board

DETAIL:

STRUCTURAL
CENTRAL STONE WALL DETAIL

State of the project:	EXECUTIVE PROJECT	Drawing number:
Scale:	1:20	
Date:	07 / 2011	


OT07

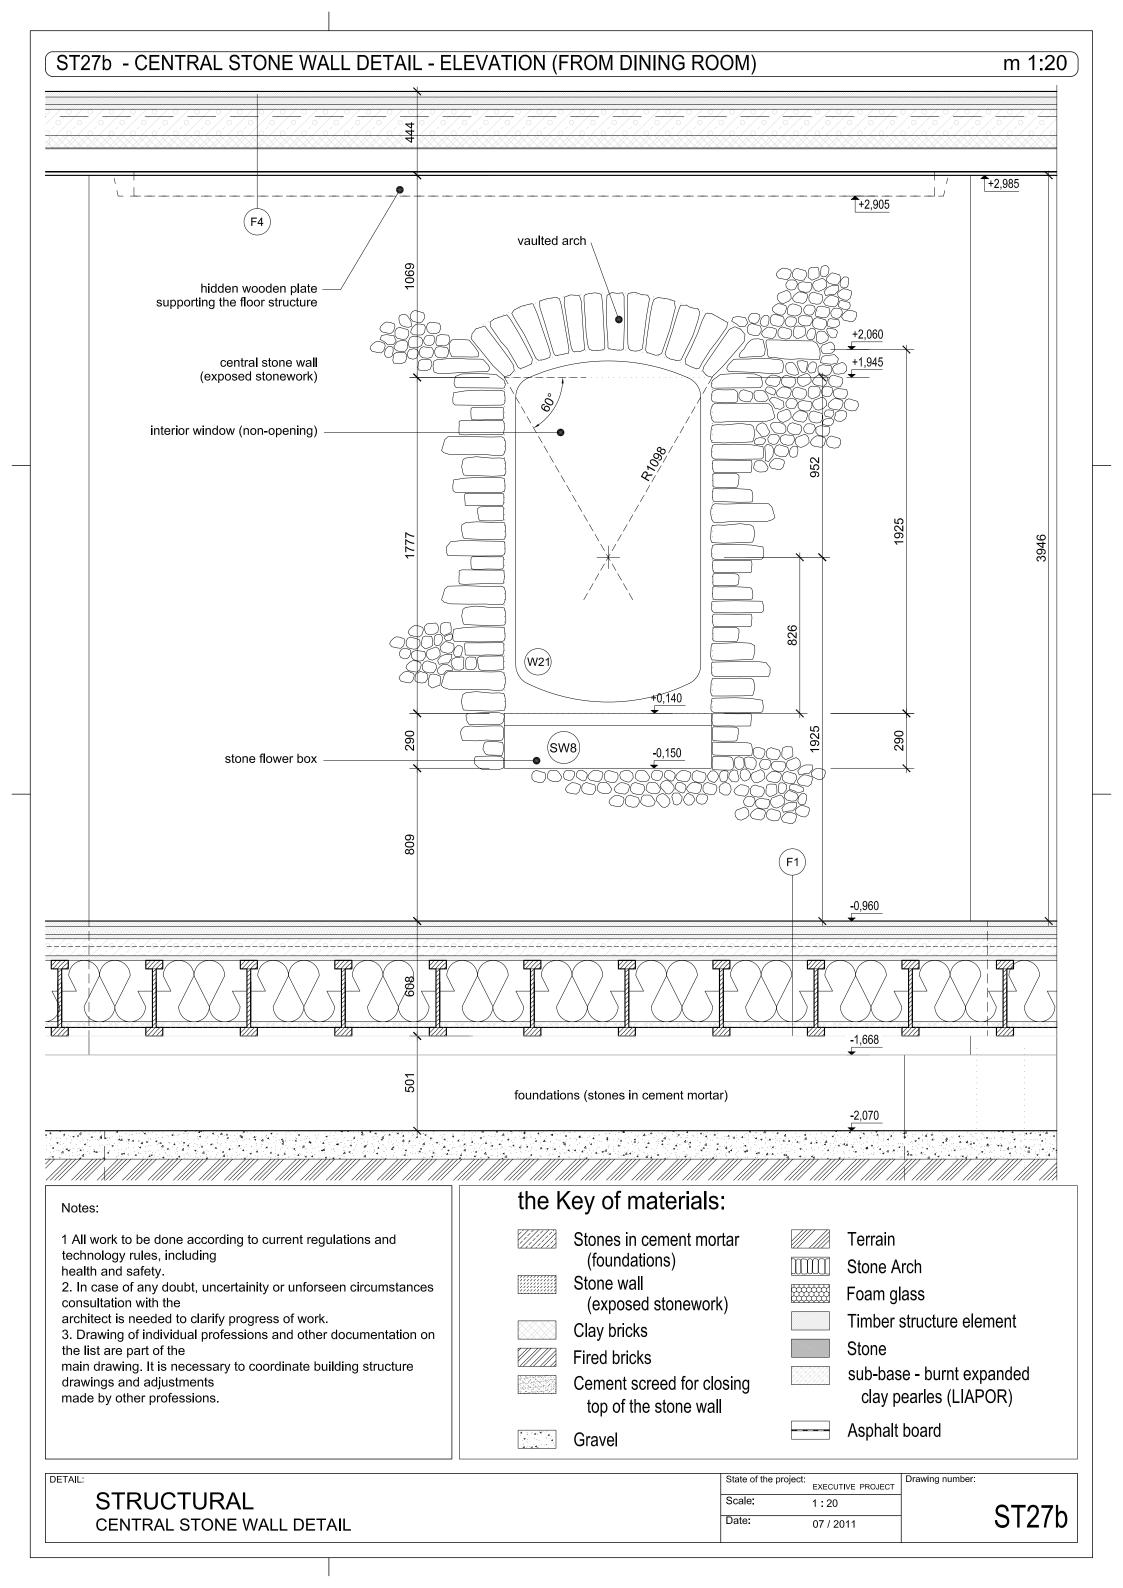

ST28 DETAIL OF AWNING'S EXPANSION DRIP LEDGE ENDING

m 1:20

see North elevation

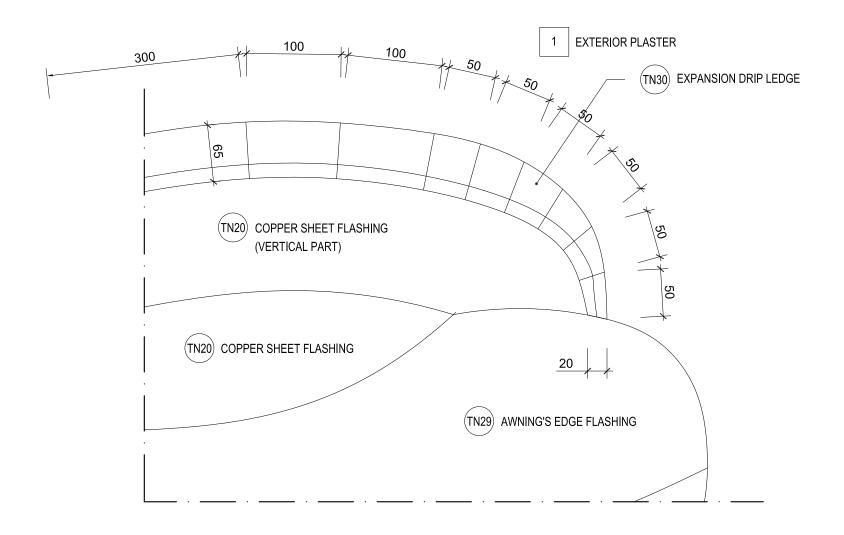

Notes:

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the Key of materials:

Stones in cement mortar (foundations)

Stone wall

(exposed stonework)

Clay bricks
Fired bricks

Cement screed for closing top of the stone wall

Gravel

Terrain

Stone Arch

Foam glass
Timber structure element

Stone

sub-base - burnt expanded

clay pearles (LIAPOR)

Asphalt board


DETAIL:

STRUCTURAL

AWNING'S EXPANSION DRIP LEDGE ENDING - ELEVATION

State of the project:	EXECUTIVE PROJECT	С
Scale:	1:20	
Date:	07 / 2011	

Drawing number:

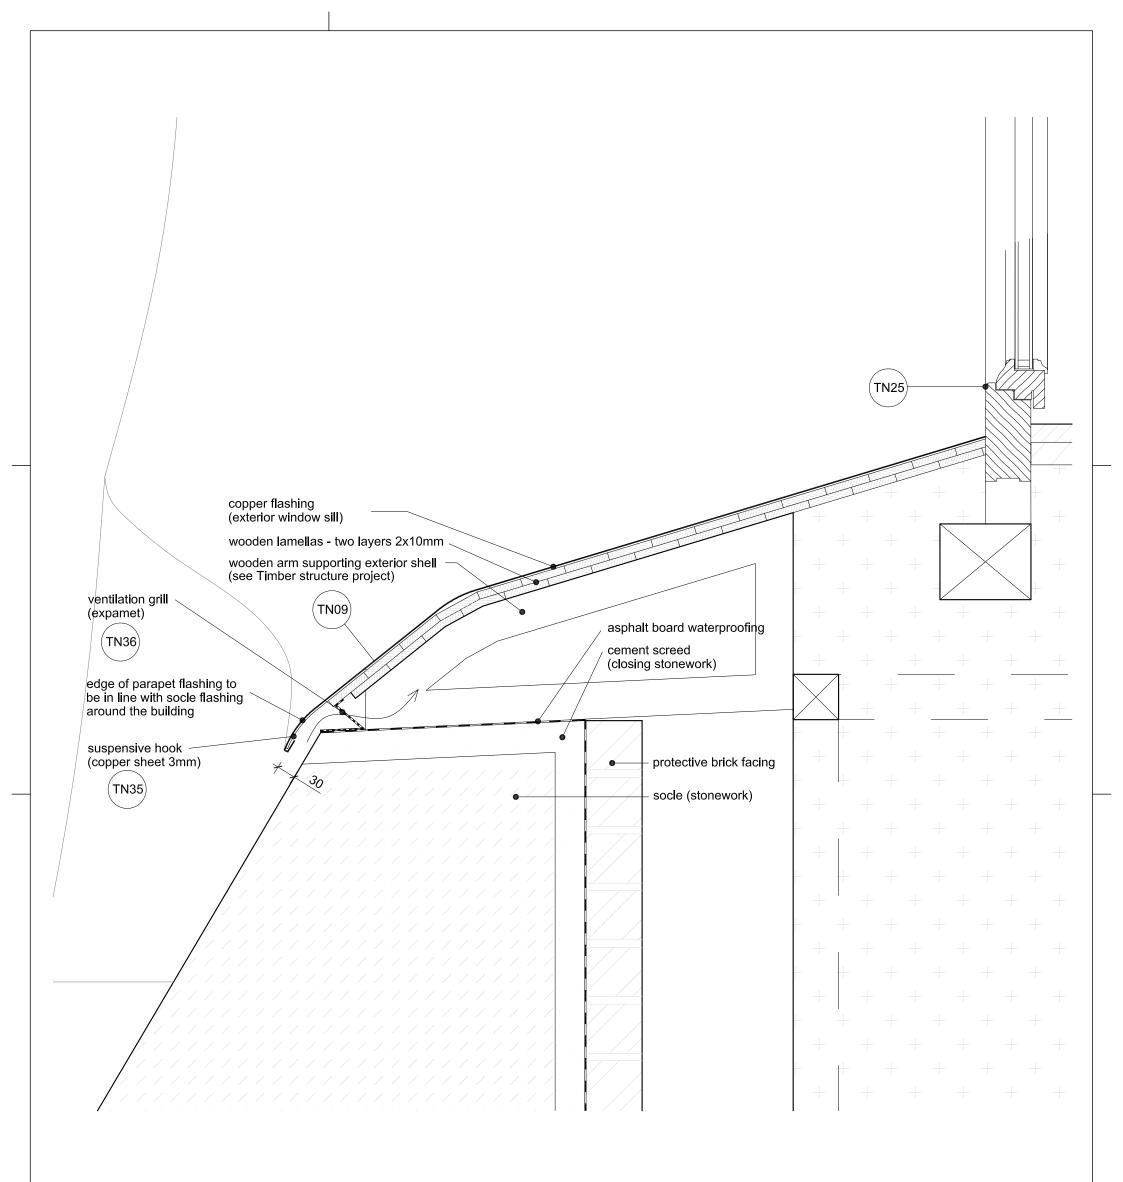



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Stone wall

(exposed stonework)

Clay bricks

Fired bricks

Cement screed for closing top of the stone wall

Gravel

_______Terrain

Stone Arch

Foam glassTimber structure element

Stone

sub-base - burnt expanded clay pearles (LIAPOR)

Asphalt board

DETAIL:

STRUCTURAL

DETAIL OF PARAPET FLASHING TO STONE SOCLE CONNECTION

State of the project: EXECUTIVE PROJECT

Scale: 1:5

Date: 07 / 2011

Drawing number: