Project

the private house in El Palol

property: Mas Palol (Can Fages), municipal area: Torroella de Fluvià, county: l'Alt Empordà, Spain

Investor:

Zain Maitreya, s.l., Margenat 23, 08017 Barcelona, Spain



ak. arch. Oldřich Hozman

Na Zájezdu 16, 101 00 Praha 10

Czech Republic

Czech Chamber of Archifects Reg. no.: 01284


tel + 4 2 0 2 3 5 3 1 1 6 2 2

gax + 4 2 0 2 3 5 3 1 1 6 2 2

www.arc.cz | arc@arc.cz

Architect: ak. arch. Oldrich Hozman	Drawn by: Ing. arch. Jan Soukup Ing. Tomas Stopka	Profession: CONSTRUCTION	Format:
Structural engineer:		Checked by:	^3
Joan Carles Capilla Ten and Maria Pia Monaco Baques, arquitectes		arch. Arturo de la Maza	

	'		
Drawing:	Project stage:	EXECUTIVE PROJECT	Drawing number:
STRUCTURAL	Scale:		C
PARTICULAR SECTIONS	Date:	07 / 2011	5

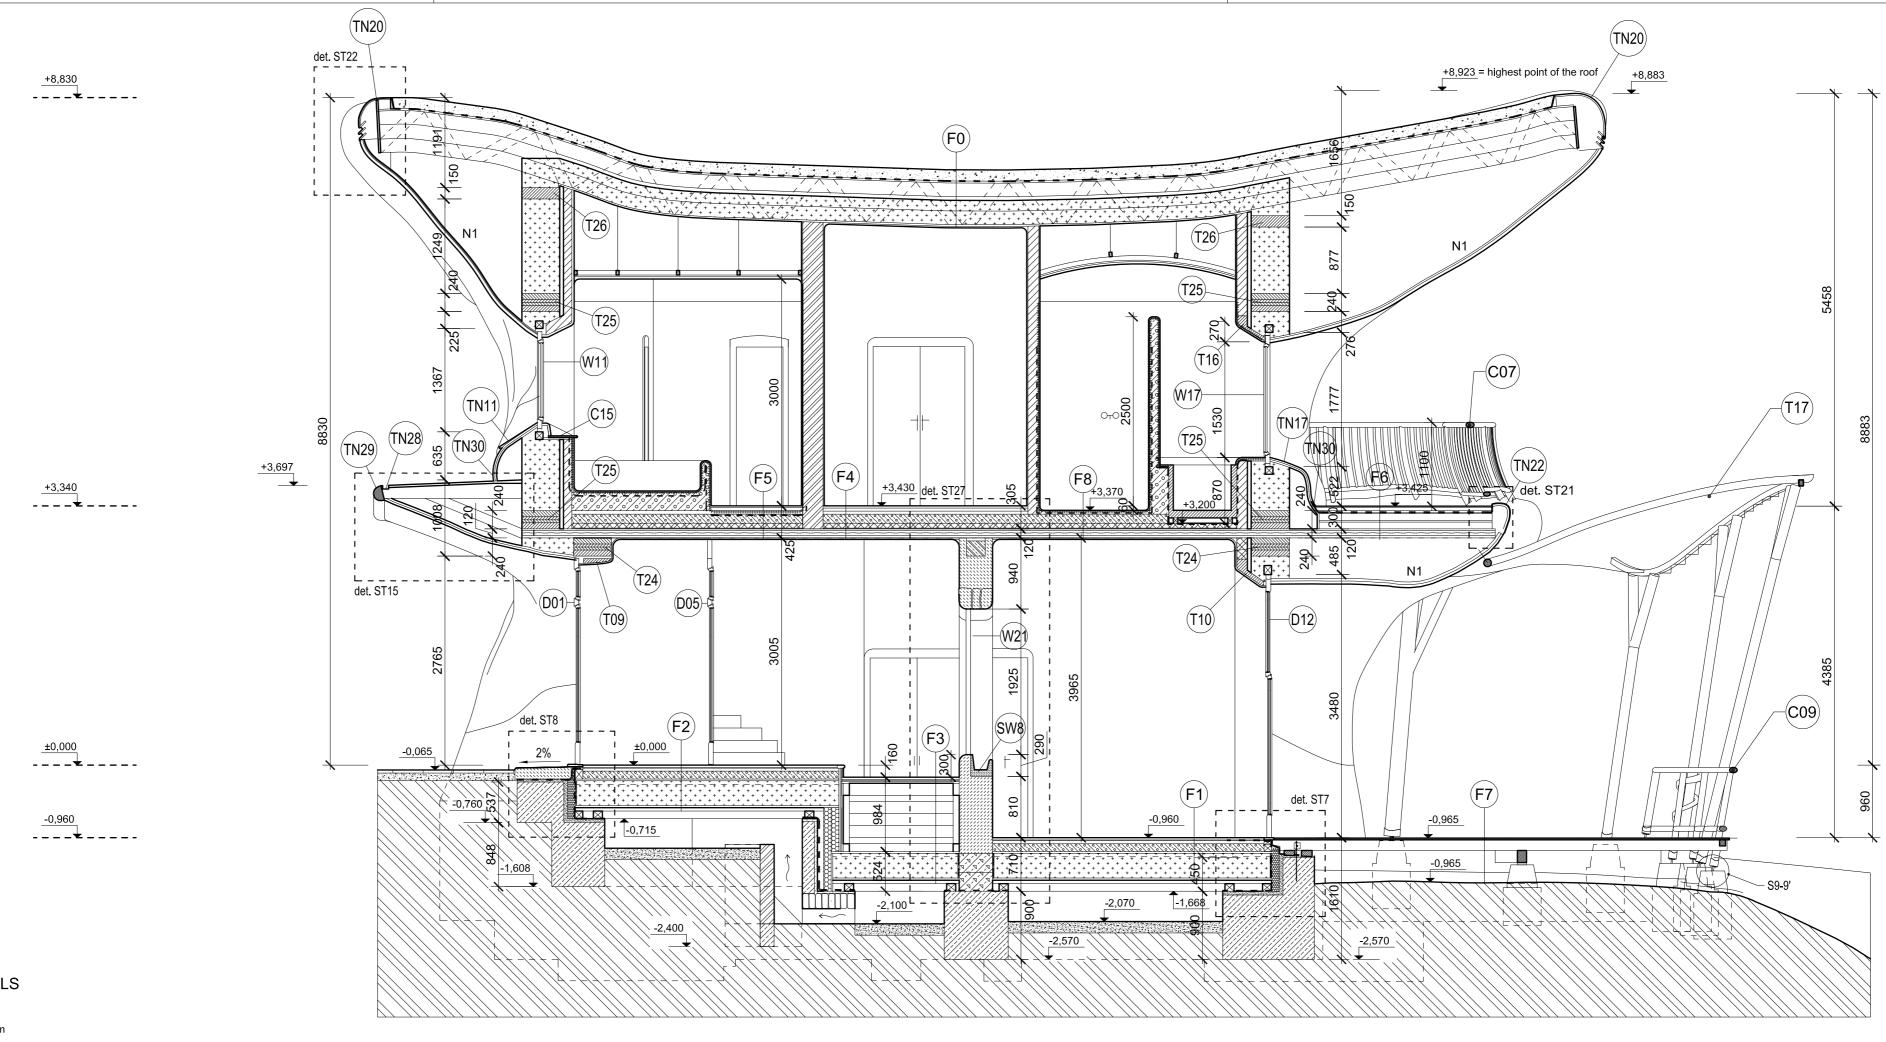

THE KEY OF MATERIALS

BRICKWORK TH.140mm

BRICKWORK TH.270mm

CLAY-BRICKWORK TH.140mm

STONEWORK (EXPOSED) TH.450mm

AAC BLOCKS (YTONG) TH.75mm

AAC BLOCKS (YTONG) TH.150mm

THERMO-INSULATING LOAD-BEARING BLOCK TH.270mm

THERMO-INSULATING BLOCK TH.150mm

प्रियम्पर्देशे THERMAL INSULATION - ROCKWOOL

THERMAL INSULATION - STRAW BALES TH.500mm bale dimensions: 350x500x700mm, density 90kg/m3

STRUCTURE WITH TADELAKT FINISH

tadelakt surface (2mm) on base screed (3mm)

STRUCTURE WITH TADELAKT FINISH
AND LIQUID EPDM WATERPROOFING MEMBRANE

applied beneath the tadelakt base screed (bath, shower)

ALL INTERNAL SURFACES: CLAY PLASTER, UNLESS SHOWN OTHERWISE

ALL AREAS WITH PRESCRIBED STRAW-BALE INSULATION, WHERE THE WHOLE BALE DOES NOT FIT, TO BE STUFFED WITH LOOSE STRAW AND MANUALLY COMPACTED TO REQUIRED DENSITY OF 90kg/m3

NOTES:


N1: For details of supporting structure for outer shell please see Timber structure project.


Notes:

- 1 All work to be done according to current regulations and technology rules, including health and safety.
- 2. In case of any doubt, uncertainity or unforseen circumstances consultation with the architect is needed to clarify progress of work.
- 3. Drawing of individual professions and other documentation on the list are part of the main drawing. It is necessary to coordinate building structure drawings and adjustments made by other professions.

+0,000 = 51,55 meters of the survey +0,000 = 25,35 meters above the sea

	20,00 11000				
Project:	the private house in El Palol property: Mas Palol (Can Fages), municipal area: Torroella de Fluvià, county: l'Alt Empordà, Spain nvestor: the private house in El Palol ak. arch Na Zájezdu Cze Czech Chambero tel + 4 2 C fax + 4 2 C			Didřich Hozman 5, 101 00 Praha 10 Republic rchitects Reg. no.: 01284 3 5 3 1 1 6 2 2 2 3 5 3 1 1 6 2 2 arc@arc.cz	
Architect:	ak. arch. Oldrich Hozman	Drawn by: Ing. arch. Jan Soukup Ing. Tomas Stopka	Profession: CON	STRUCTION	Format:
Structural engineer: Joan Carles Capilla Ten and Maria Pia Monaco Baques, arquitectes		Checked by: arch.	Arturo de la Maza	A2	
Drawing:			Project stage:	EXECUTIVE PROJECT	Drawing number:
	S1		Scale:	1:50	004
	CROSS SECTION		Date:	07 / 2011	S01

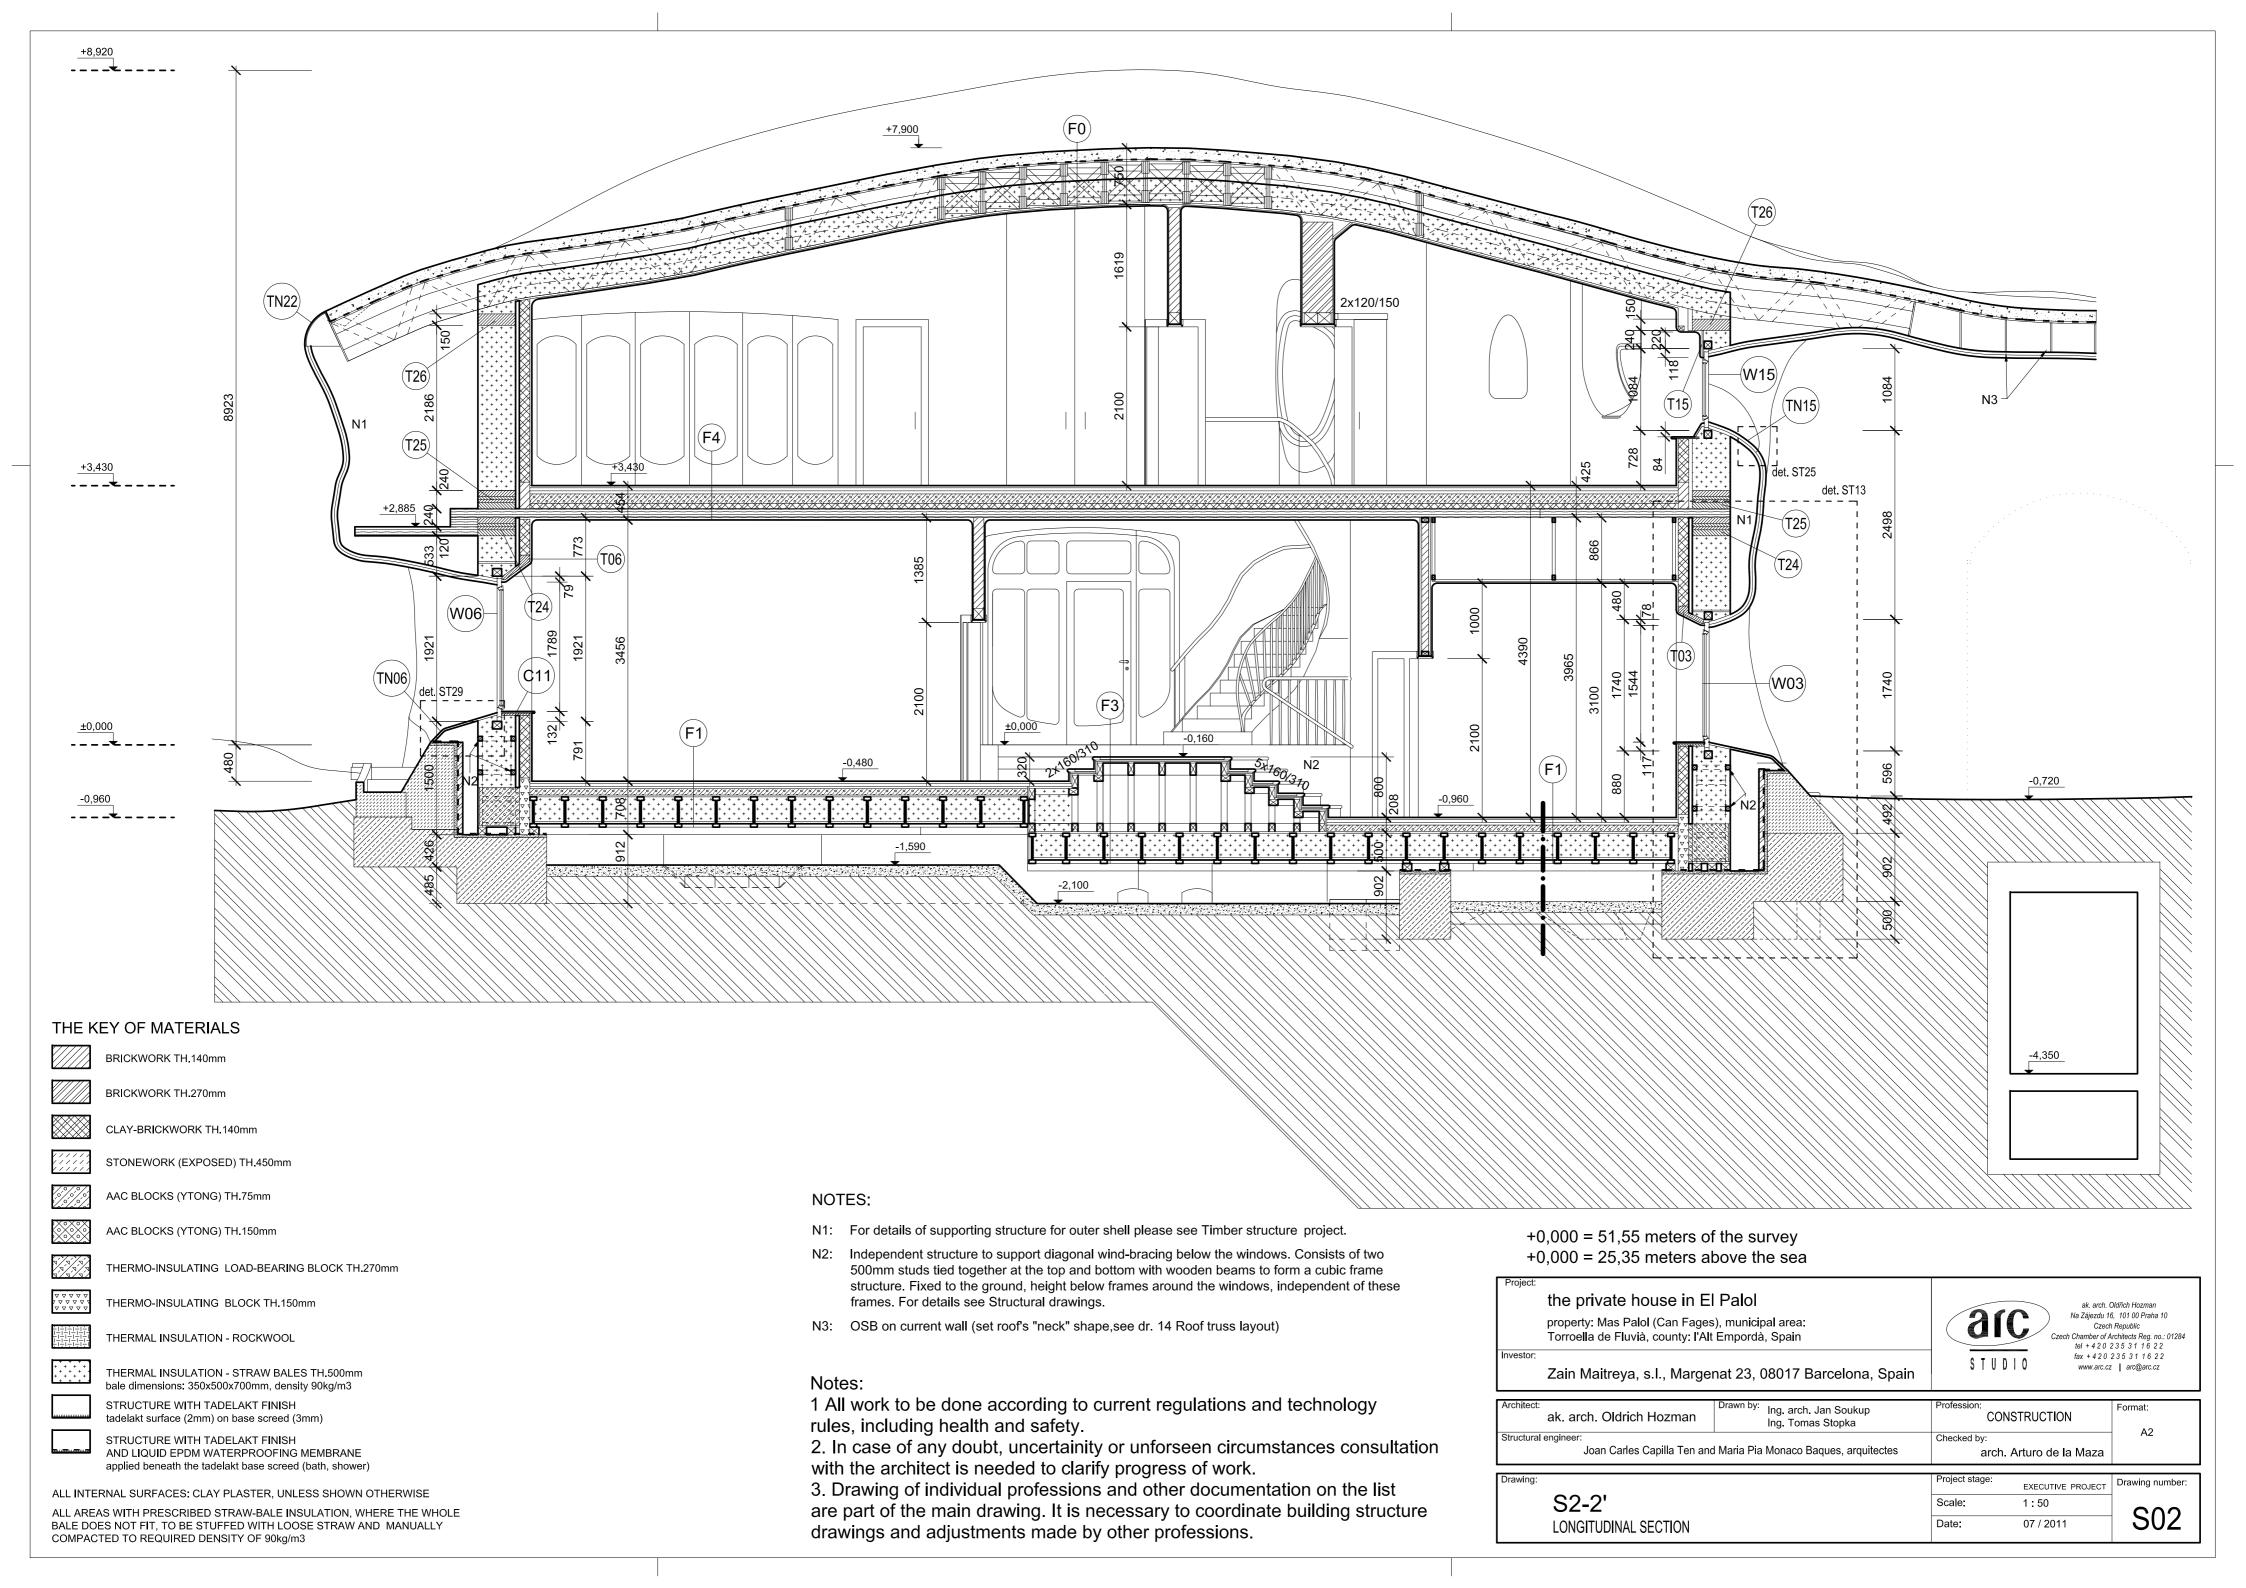

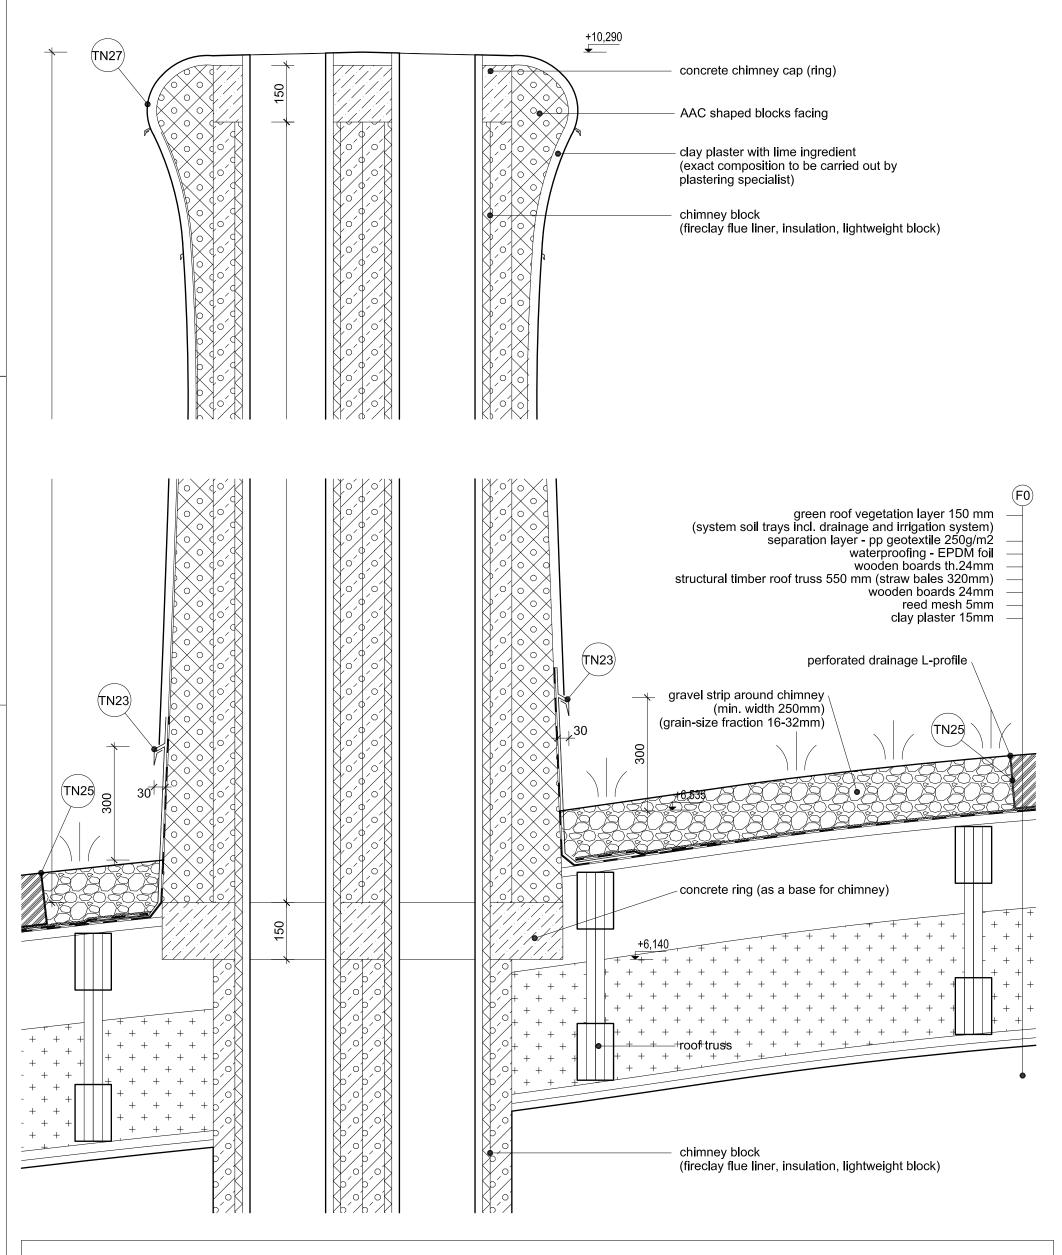

Notes:


- 1 All work to be done according to current regulations and technology rules, including health and safety.
- 2. In case of any doubt, uncertainity or unforseen circumstances consultation with the architect is needed to clarify progress of work.
- 3. Drawing of individual professions and other documentation on the list are part of the main drawing. It is necessary to coordinate building structure drawings and adjustments made by other professions.

DETAIL:	
	SECTION S3
	DETAIL OF CHIMNEY STRUCTURE

State of the project:	EXECUTIVE PROJECT	Drawing number:
Scale:	1:10	
Date:	07 / 2011	

S4-4' m 1:20

TERRACE - COLUMN ON SOCLE, RAILING'S ENDING

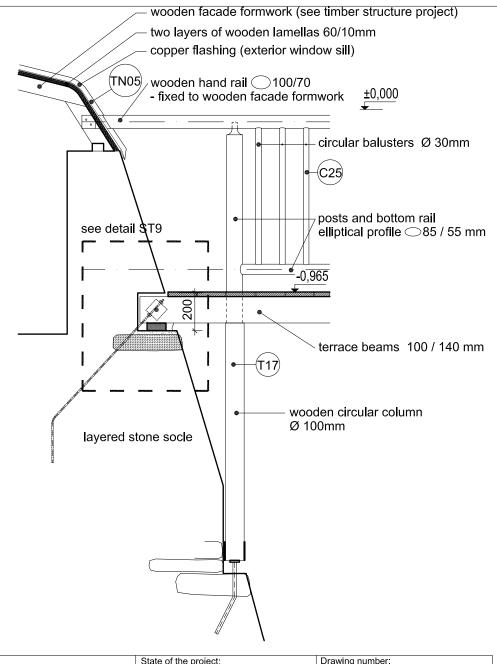

Notes:


- 1 All work to be done according to current regulations and technology rules, including health and safety.
- 2. In case of any doubt, uncertainity or unforseen circumstances consultation with the architect is needed to clarify progress of work.
- 3. Drawing of individual professions and other documentation on the list are part of the main drawing. It is necessary to coordinate building structure drawings and adjustments made by other professions.

DETAIL:

SECTION S4

Terrace - column on socle, railing's ending

State of the project:	EXECUTIVE PROJECT	Drawing numb
Scale:	1:20	
Date:	07 / 2011	

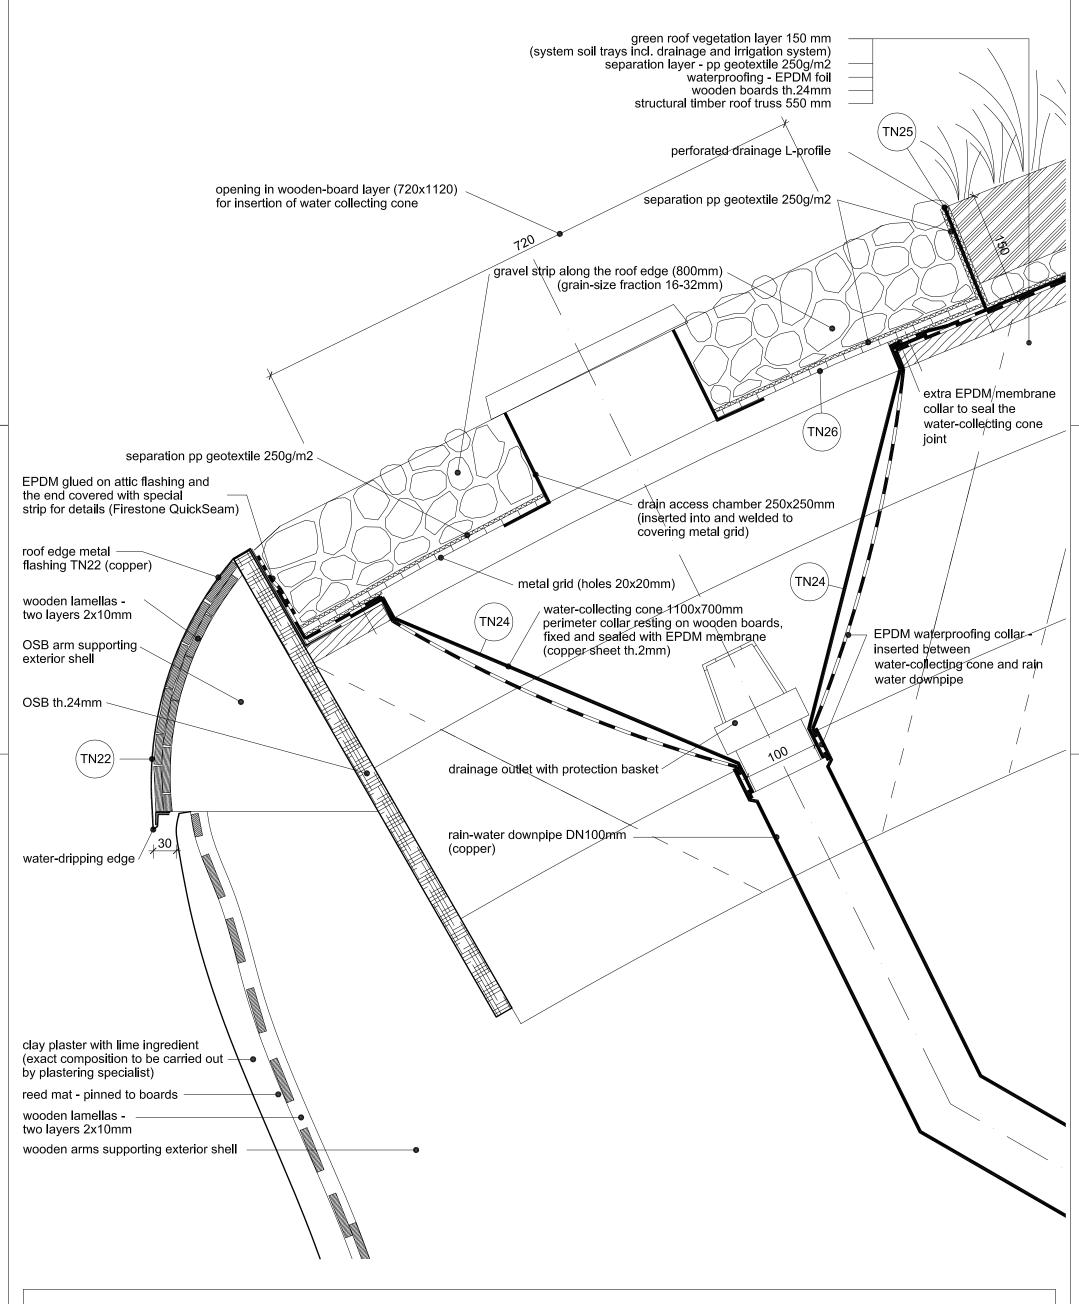


Notes:

- 1 All work to be done according to current regulations and technology rules, including health and safety.
- 2. In case of any doubt, uncertainity or unforseen circumstances consultation with the architect is needed to clarify progress of work.
- 3. Drawing of individual professions and other documentation on the list are part of the main drawing. It is necessary to coordinate building structure drawings and adjustments made by other professions.

SECTION S05
DETAIL OF ROOF DRAINAGE OUTLET

State of the project:	EXECUTIVE PROJECT	Drawing number:
Scale:	1:5	
Date:	07 / 2011	

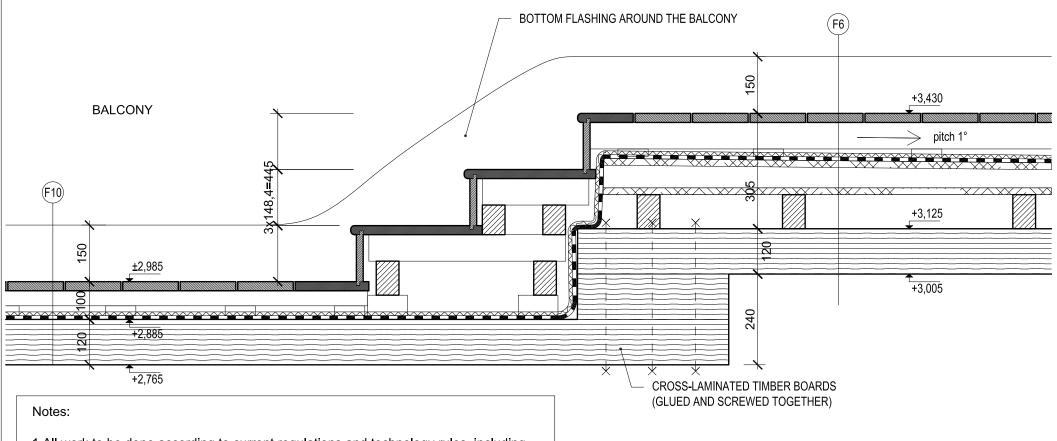

- 1 All work to be done according to current regulations and technology rules, including health and safety.
- 2. In case of any doubt, uncertainity or unforseen circumstances consultation with the architect is needed to clarify progress of work.
- 3. Drawing of individual professions and other documentation on the list are part of the main drawing. It is necessary to coordinate building structure drawings and adjustments made by other professions.


SPACE INSIDE THE SHELL

DETAIL:

SECTION S6
Balcony stairs - leading to lowered part

State of the project:	EXECUTIVE PROJECT	I
Scale:	1:10	
Date:	07 / 2011	

Drawing number:

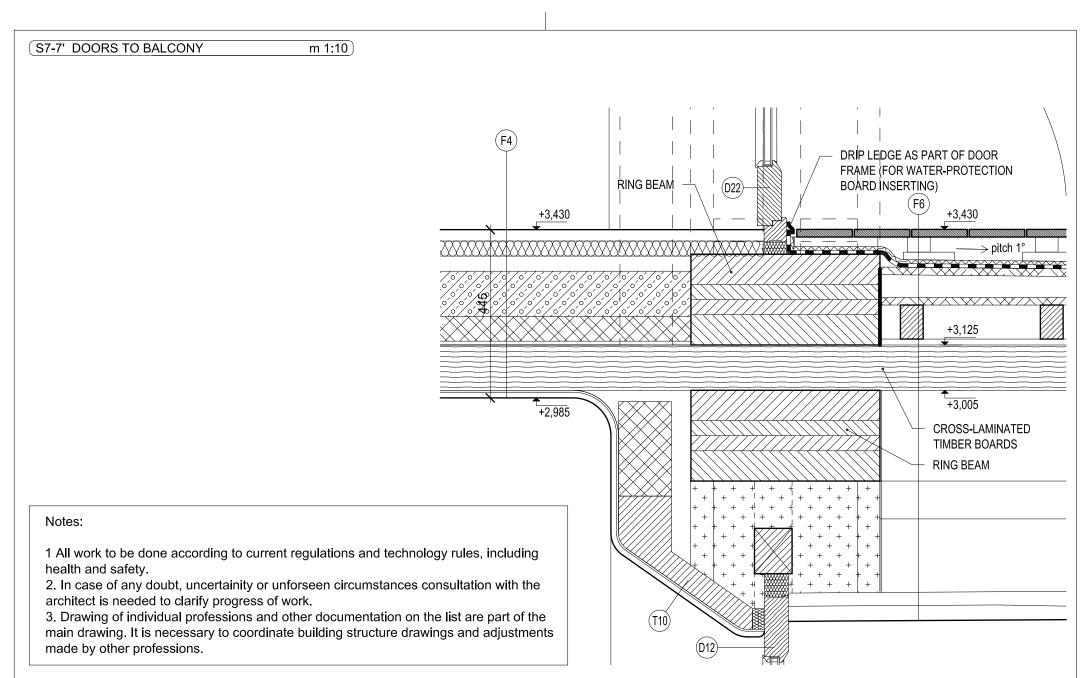


DETAIL:

SECTION S7

Doors to balcony- threshold detail


State of the project:	EXECUTIVE PROJECT	Drawing number:
Scale:	1:10	
Date:	07 / 2011	

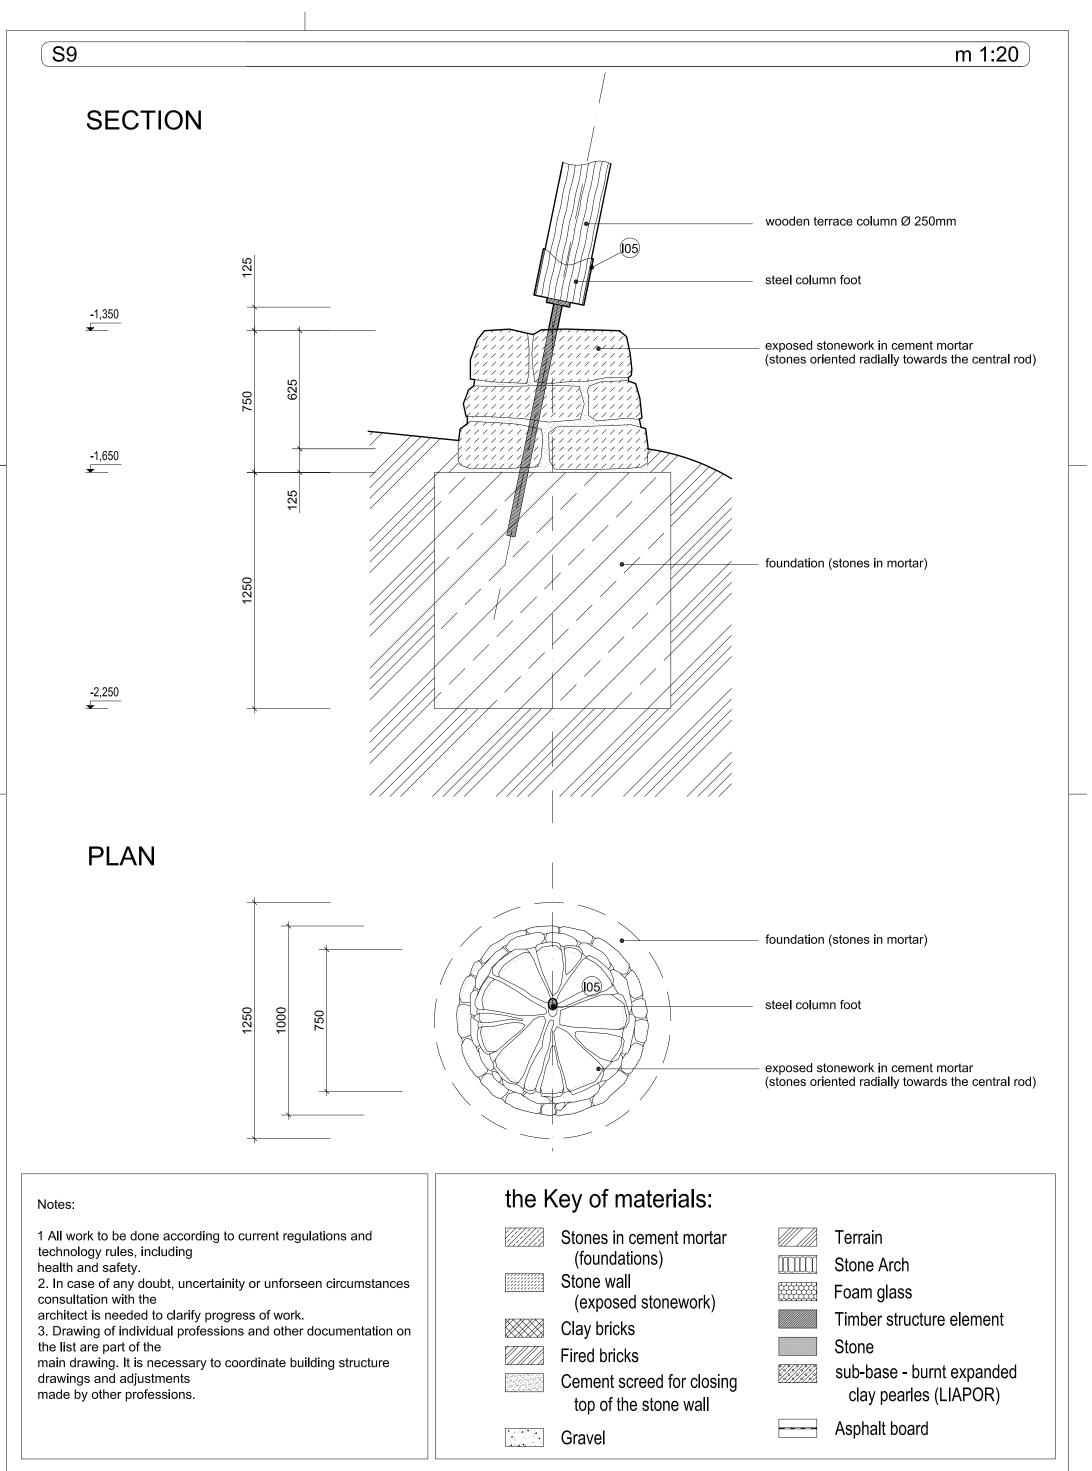

SECTION S9
TERRACE COLUMN FOOT

State of the project: EXECUTIVE PROJECT
Scale: 1:20
Date: 02 / 2010
Drawing number:

Section 10-10' m 1:10

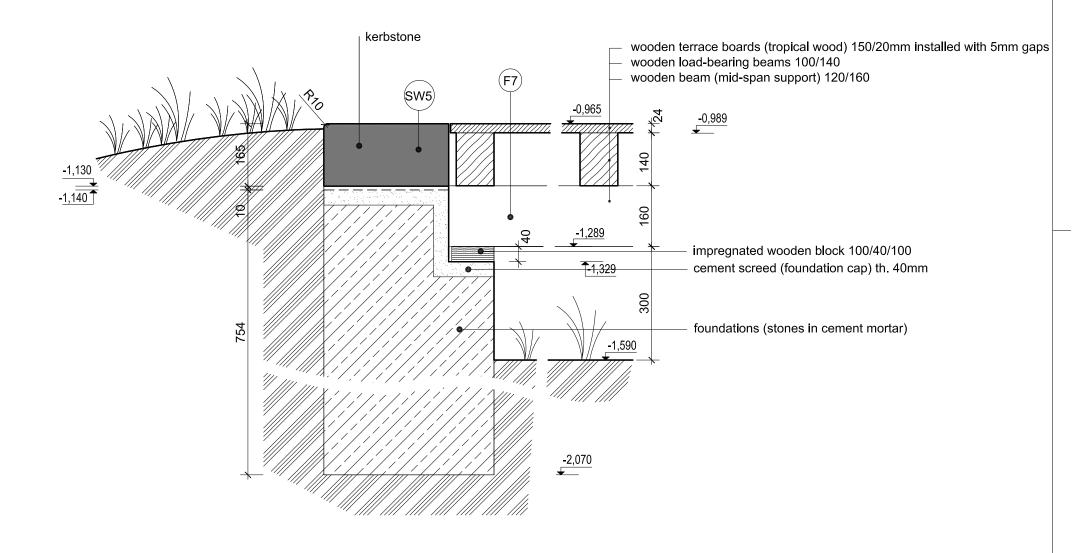

Notes:

- 1 All work to be done according to current regulations and technology rules, including health and safety.
- 2. In case of any doubt, uncertainity or unforseen circumstances consultation with the

architect is needed to clarify progress of work.

3. Drawing of individual professions and other documentation on the list are part of the

main drawing. It is necessary to coordinate building structure drawings and adjustments made by other professions.

the Key of materials:

Stones in cement mortar (foundations)

Stone wall (exposed stonework)

Clay bricks

Fired bricks

Cement screed for closing top of the stone wall

Gravel



Terrain

Stone Arch

Foam glass

Timber structure element

Stone

sub-base - burnt expanded clay pearles (LIAPOR)


Asphalt board

DETAIL:

SECTION S10-10' **DETAIL OF TERRACE EDGE**

State of the project:	EXECUTIVE PROJECT	Drawing number:
Scale:	1:10	
Date:	07 / 2011	

Section 15 m 1:50

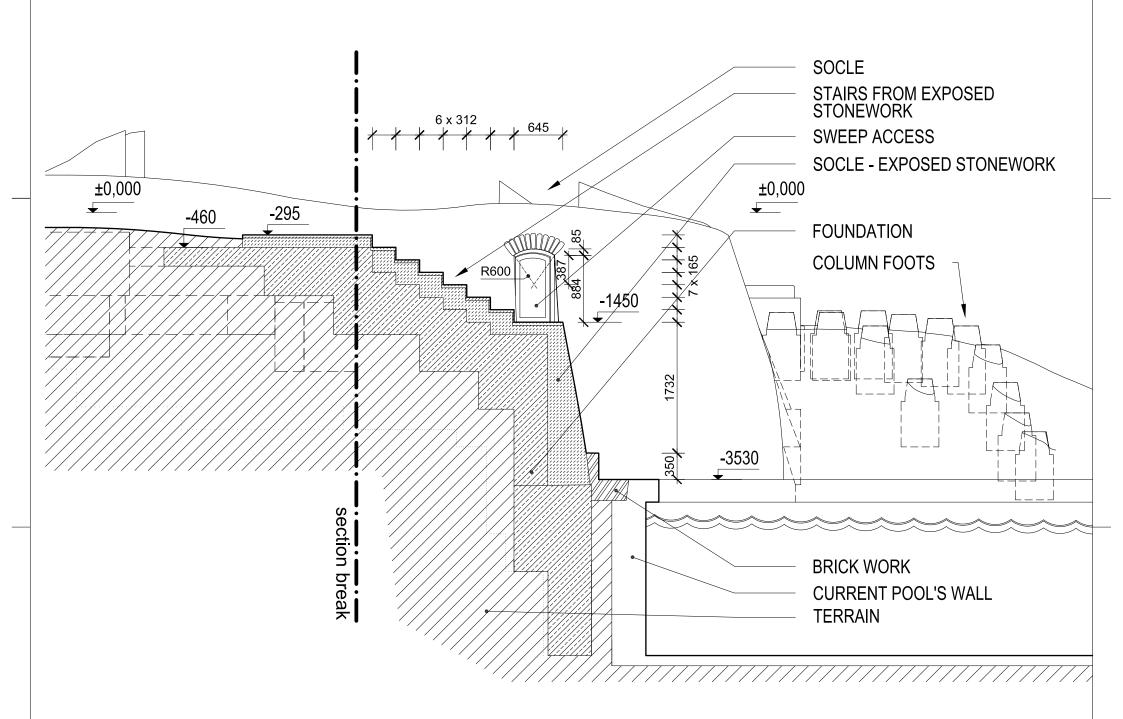

Notes:

- 1 All work to be done according to current regulations and technology rules, including health and safety.
- 2. In case of any doubt, uncertainity or unforseen circumstances consultation with the
- architect is needed to clarify progress of work.
- 3. Drawing of individual professions and other documentation on the list are part of the

main drawing. It is necessary to coordinate building structure drawings and adjustments made by other professions.

the Key of materials:

Stones in cement mortar

(foundations)

Stone wall (exposed stonework)

Clay bricks
Fired bricks

Cement screed for closing top of the stone wall

Gravel

////// Terrain

Stone Arch
Foam glass

Timber structure element

Stone

sub-base - burnt expanded clay pearles (LIAPOR)

Asphalt board

DETAIL:

SECTION S15
EXTERIOR STAIRCASE LEADING TO SWEEP ACCESS


State of the project:

Scale: 1:50

Date: 07 / 2011

Drawing number:

Section 17 m 1:10

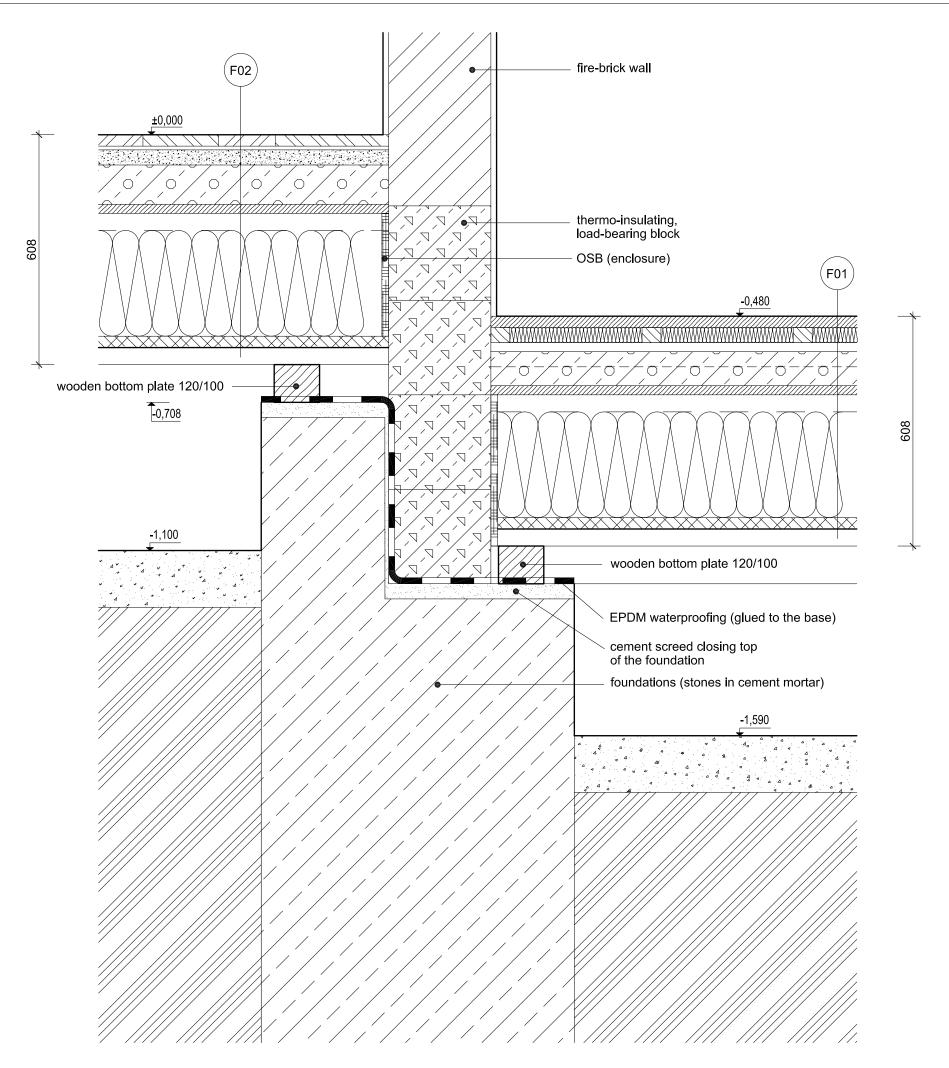

Notes:

- 1 All work to be done according to current regulations and technology rules, including health and safety.
- 2. In case of any doubt, uncertainity or unforseen circumstances consultation with the
- architect is needed to clarify progress of work.
- 3. Drawing of individual professions and other documentation on the list are part of the

main drawing. It is necessary to coordinate building structure drawings and adjustments made by other professions.

the Key of materials:

Stor

Stones in cement mortar (foundations)

Sto

Stone wall (exposed stonework)

Clay bricks

Cement screed for closing top of the stone wall

Fired bricks

Gravel

///// Terrain

Stone Arch

Foam glass

Timber structure element

Stone

sub-base - burnt expanded clay pearles (LIAPOR)

Asphalt board

DETAIL:

SECTION S17
TWO-LEVELS-FLOOR JOINT


State of the project: EXECUTIVE PROJECT

Scale: 1:10

Date: 07 / 2011

Drawing number:

Section 18 m 1:10

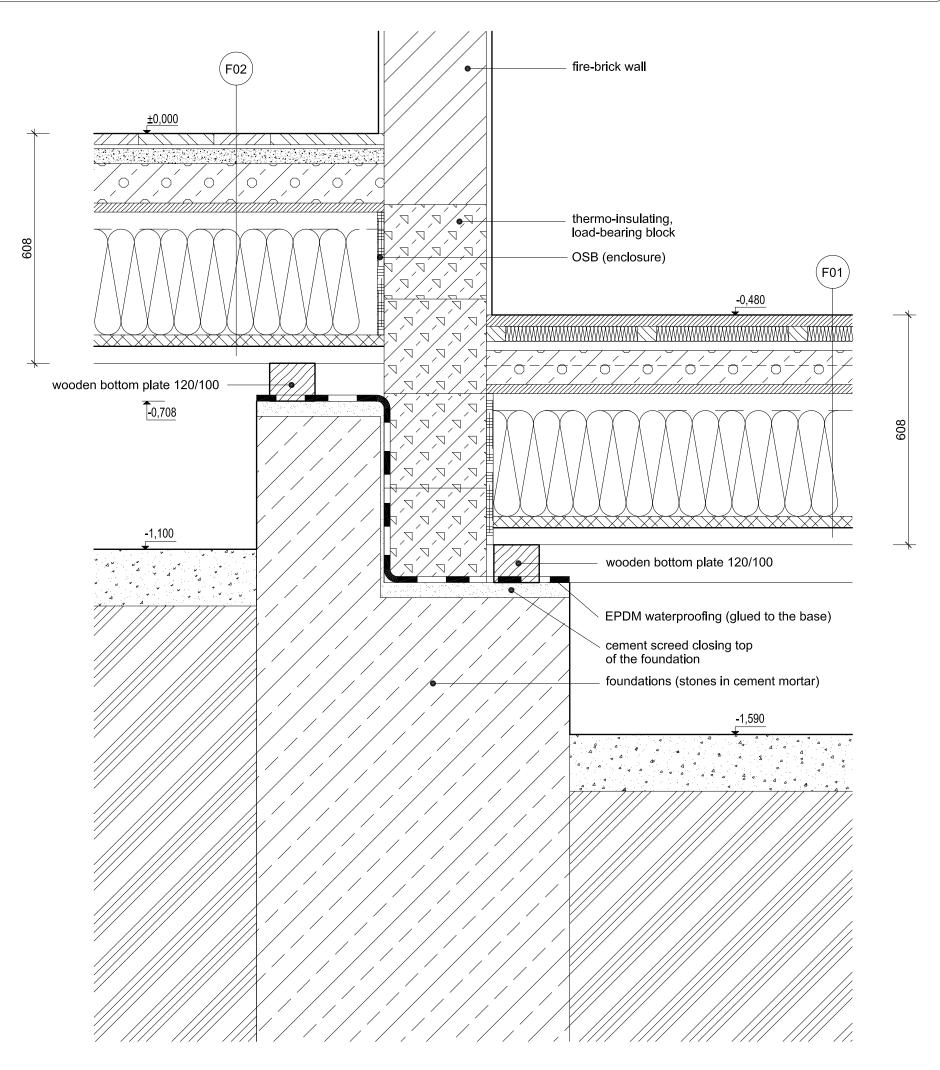

Notes:

- 1 All work to be done according to current regulations and technology rules, including health and safety.
- 2. In case of any doubt, uncertainity or unforseen circumstances consultation with the

architect is needed to clarify progress of work.

3. Drawing of individual professions and other documentation on the list are part of the

main drawing. It is necessary to coordinate building structure drawings and adjustments made by other professions.

the Key of materials:

Stones in cement mortar (foundations)



Stone wall (exposed stonework)



Clay bricks



Fired bricks

Cement screed for closing top of the stone wall



Gravel



Terrain



Stone Arch Foam glass



Timber structure element

clay pearles (LIAPOR)



Stone sub-base - burnt expanded


Asphalt board

DETAIL:

SECTION S18 TWO-LEVELS-FLOOR JOINT

State of the project: EXECUTIVE PROJECT Scale: 1:10 Date: 07 / 2011

Drawing number:

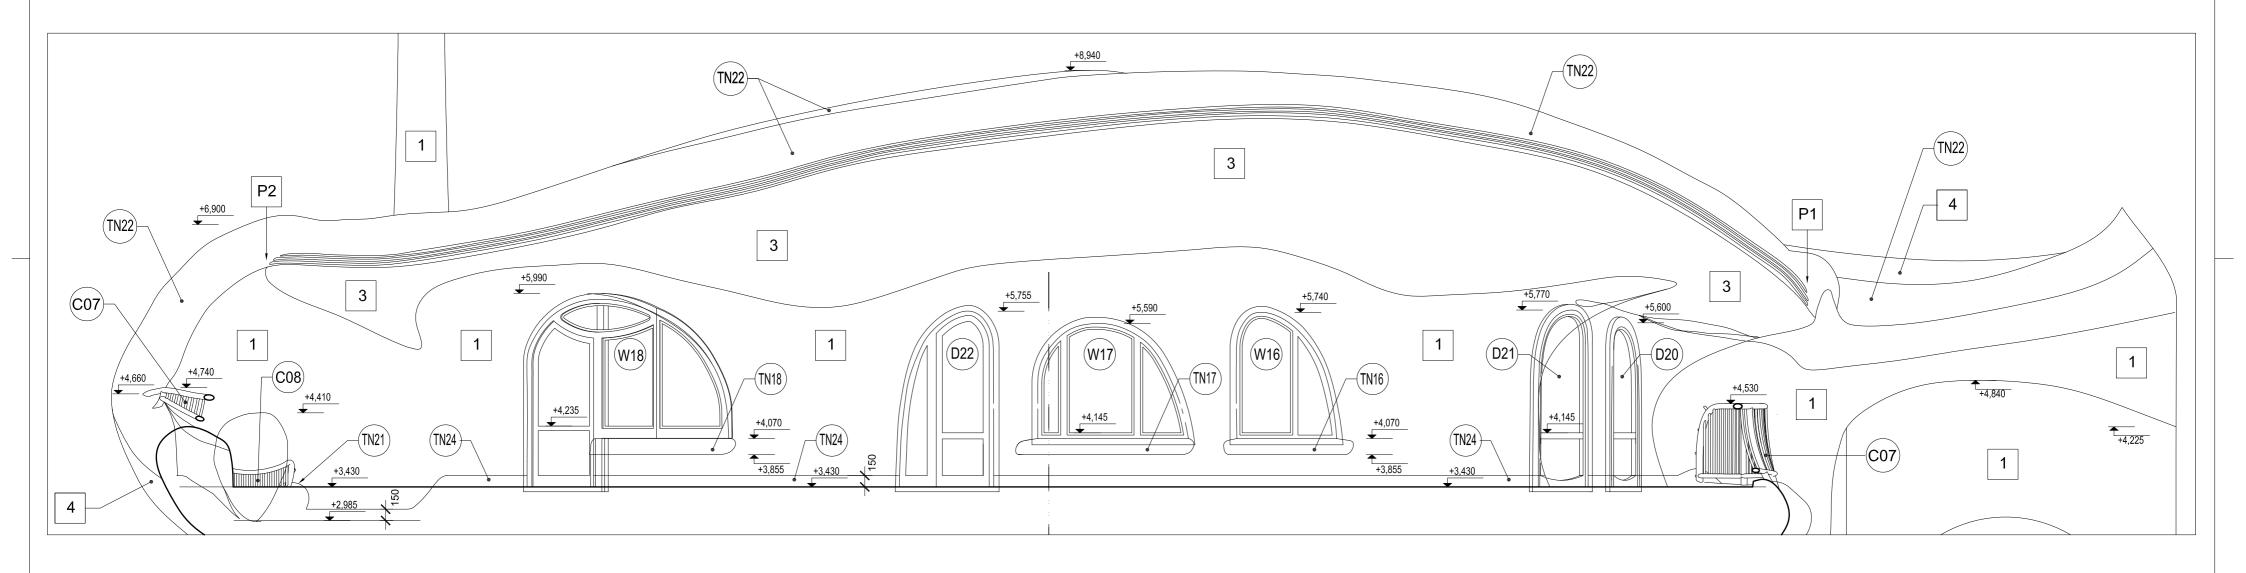

Key of notes:

1

TYPE OF SURFACE

Clay plaster (20 mm + 20 mm)

Stonework

Wooden lamellas - radial orientation

Green roof

Rubble - green roof's border

ELEMENTS

Carpentery Doors

Ironmongery

Timber elements ΤN Thinner elelments

Stoneworks SW Windows W

Notes:

- 1 All work to be done according to current regulations and technology
- rules, including health and safety.

 2. In case of any doubt, uncertainity or unforseen circumstances consultation with the architect is needed to clarify progress of work.
- 3. Drawing of individual professions and other documentation on the list are part of the main drawing. It is necessary to coordinate building structure drawings and adjustments made by other professions.

+0,000 = 51,55 meters of the survey +0,000 = 25,35 meters above the sea

Pro	ot:	
	the private house in El Palol	
	property: Mas Palol (Can Fages), municip Torroella de Fluvià, county: l'Alt Empordà	
Inve	or:	
	Zain Maitreya, s.l., Margenat 23, (08017 Barcelona, Spain



ak. arch. Oldřich Hozman


Na Zájezdu 16, 101 00 Praha 10
Czech Republic


Czech Chamber of Architects Reg. no.: 01284
tel + 4 2 0 2 3 5 3 1 1 6 2 2
fax + 4 2 0 2 3 5 3 1 1 6 2 2
www.arc.cz | arc@arc.cz

Architect: ak. arch. Oldrich Hozman	Drawn by: Ing. arch. Jan Soukup Ing. Tomas Stopka	Profession: CONSTRUCTION	Format:
ı		Checked by:	\ \\Z
Joan Carles Capilla Ten and	arch. Arturo de la Maza		

g:	Project stage:	EXECUTIVE PROJECT	Drawing number:
S19	Scale:	1:100	040
SOUTH ELEVATION - BALCONY VIEW	Date:	07 / 2011	519

SECTION 20 m 1:10

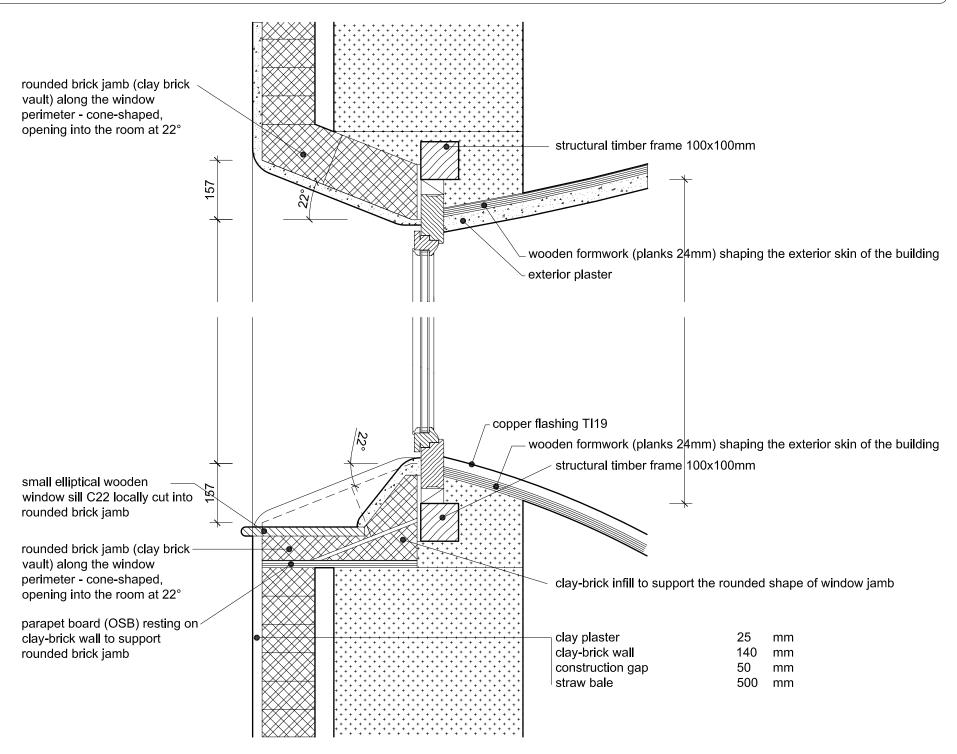

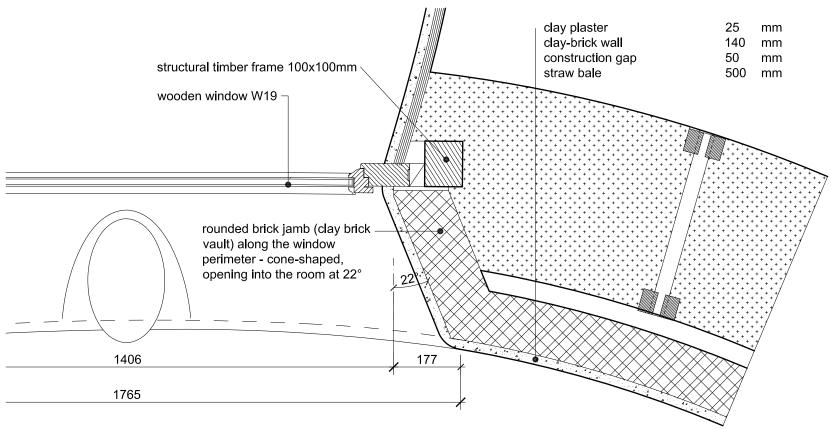

DETAIL OF ROUND WINDOW BRICK JAMB - PLAN 1:10

Notes:

- 1 All work to be done according to current regulations and technology rules, including health and safety.
- 2. In case of any doubt, uncertainity or unforseen circumstances consultation with the architect is needed to clarify progress of work.
- 3. Drawing of individual professions and other documentation on the list are part of the main drawing. It is necessary to coordinate building structure drawings and adjustments made by other professions.


SECTION S20-20'
DETAIL OF ROUND WINDOW SILL AND HEAD

State of the project: EXECUTIVE PROJECT Scale: 1:10
Date: 02/2010

Date: 02/2010

Drawing number: S20

SECTION 21 m 1:20

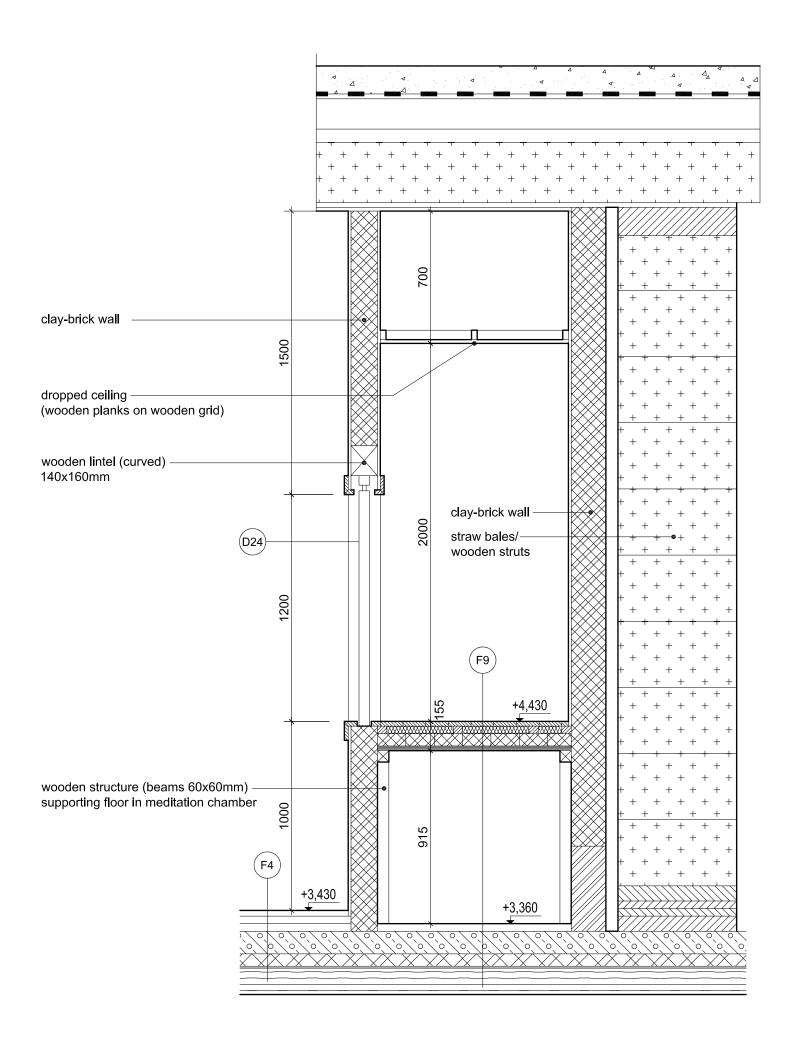

Notes:

- 1 All work to be done according to current regulations and technology rules, including health and safety.
- $2. \ \mbox{In case}$ of any doubt, uncertainity or unforseen circumstances consultation with the
- architect is needed to clarify progress of work.
- 3. Drawing of individual professions and other documentation on the list are part of the
- main drawing. It is necessary to coordinate building structure drawings and adjustments made by other professions.

the Key of materials:

Stones in cement mortar (foundations)

Stone wall

(exposed stonework)
Clay bricks

Fired bricks

Cement screed for closing top of the stone wall

Gravel

7777	
/// //	Torroin
// ////	remain

Stone Arch

Foam glass

Timber structure element

Stone

sub-base - burnt expanded clay pearles (LIAPOR)

Asphalt board

DETAIL:


STRUCTURAL
DETAIL OF MEDITATION CHAMBER

State of the project:	EXECUTIVE PROJECT	Drawing number:
Scale:	1:20	
Date:	07 / 2011	

ST22 ATTIC WITH VENTILATION OPENINGS

m 1:5

IN SECTION S1-1'

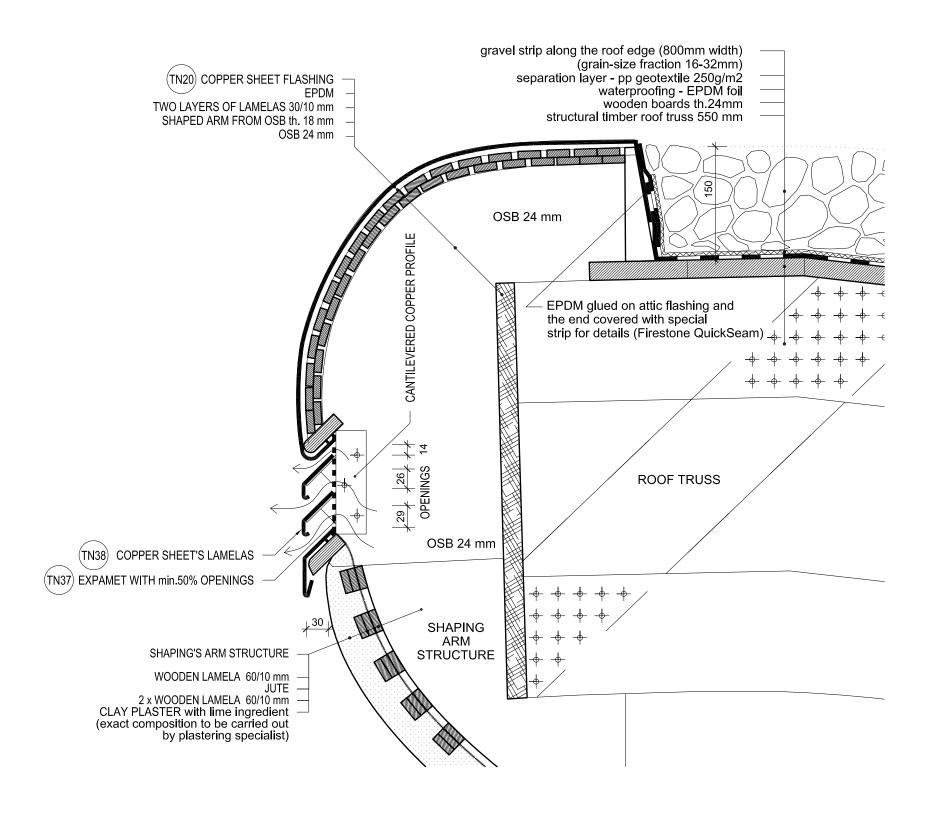

Notes:

- 1 All work to be done according to current regulations and technology rules, including health and safety.
- 2. In case of any doubt, uncertainity or unforseen circumstances consultation with the
- architect is needed to clarify progress of work.
- 3. Drawing of individual professions and other documentation on the list are part of the
- main drawing. It is necessary to coordinate building structure drawings and adjustments made by other professions.

the Key of materials:

Stones in cement mortar (foundations)

Stone wall

(exposed stonework)

Clay bricks

Fired bricks Cement screed for closing top of the stone wall

Gravel

Terrain

Stone Arch Foam glass

Timber structure element

Stone

sub-base - burnt expanded clay pearles (LIAPOR)

Asphalt board

DETAIL:

STRUCTURAL

DETAIL OF SHELL - ATTIC SOLUTION WITH VENTILATION OPENINGS

State of the project:	EXECUTIVE PROJECT	1
Scale:	1:5	
Date:	07 / 2011	

Drawing number:

ST22